


EAST WATER RECLAMATION FACILITY SCREW PUMP REPLACEMENT



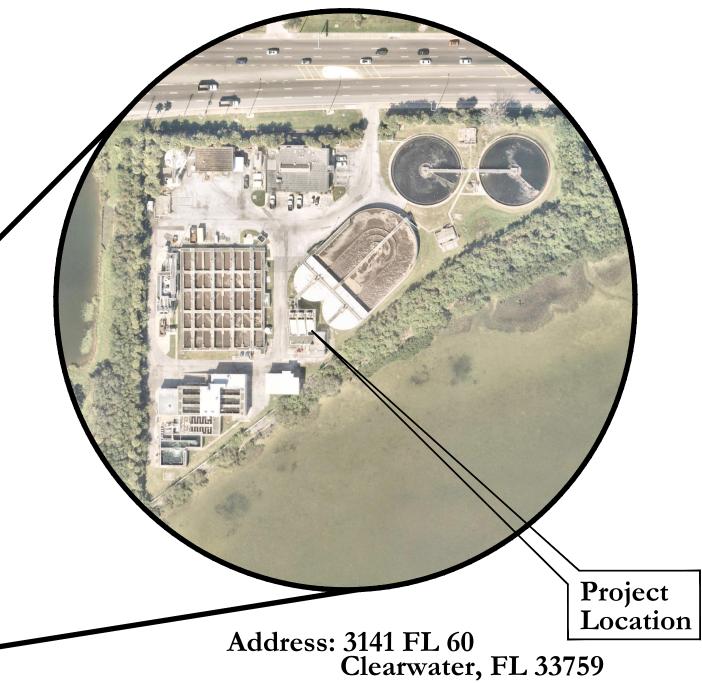

CITY OFFICIALS

Brian J. Aungst, Sr. Mark Bunker Kathleen Beckman **David Allbritton** Lina Teixeira Jennifer Poirrier

Mayor Councilmember Councilmember Councilmember Councilmember City Manager

Tara Kivett, P.E. City Engineer, Public Works

Approved For Construction

CITY ENGINEER, PUBLIC WORKS TARA KIVETT, P.E. #866

Date Approved

BID DOCUMENTS

City Project No. 22-0028-UT City Plan Set No. 2022018 *OCTOBER 2023*

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GENERAL NOTES

- NO SURVEY WAS PERFORMED EXCLUSIVELY FOR THIS PROJECT. THE SITE INFORMATION IS BASED UPON USING AVAILABLE INFORMATION INCLUDING HISTORICAL AND RECORD DRAWINGS AND FIELD MEASUREMENTS. THE CONTRACTOR IS RESPONSIBLE FOR VERIFYING ALL INFORMATION PRIOR TO
- 2. ALL ELEVATIONS ARE REFERENCED TO THE NORTH AMERICAN VERTICAL DATUM (NAVD) 1988. THE HORIZONTAL DATUM IS BASED ON FLORIDA STATE PLANE WEST, NORTH AMERICAN DATUM (NAD) 1983 (2011). SOME RECORD DRAWINGS REFERENCED WERE ON DATUM NGVD '29. THE EXISTING ELEVATIONS PROVIDED IN THESE CONTRACT DRAWINGS WERE APPROXIMATED AS 0.86 FEET BELOW THIS ELEVATION IN ACCORDANCE WITH THE NOAA ORTHOMETRIC HEIGHT CONVERSION FROM NGVD '29 TO NAVD '88 FOR LATITUDE 27° 57' 34.75" AND LONGITUDE -82° 42' 24.53". CONTRACTOR IS RESPONSIBLE FOR VERIFYING THE EXISTING ELEVATIONS. IF DIMENSIONS ARE NOT PROVIDED, THE DIFFERENCE IN THE TWO ELEVATIONS AS SHOWN ON THE CONTRACT DRAWINGS SHALL BE TAKEN AS MEASUREMENT, NOT NECESSARILY THE LISTED ELEVATION.
- 3. ALL WORK PERFORMED SHALL COMPLY WITH THE REGULATIONS AND ORDINANCES OF THE VARIOUS GOVERNMENTAL AGENCIES HAVING JURISDICTION OVER THE WORK.
- 4. ALL WORKMANSHIP AND MATERIALS USED IN THE CONSTRUCTION OF THIS PROJECT SHALL CONFORM TO THE LATEST CITY OF CLEARWATER STANDARDS, CONTRACT DOCUMENTS AND SPECIFICATIONS UNLESS OTHERWISE NOTED.
- THE CONTRACTOR SHALL OBTAIN ALL REQUIRED PERMITS PRIOR TO CONSTRUCTION. 6. ALL CONSTRUCTION ACTIVITIES MUST CONFORM TO THE LOCAL NOISE ORDINANCE.
- 7. HOURS OF WORK SHALL BE IN ACCORDANCE WITH SPECIFICATION SECTION 01100, SUMMARY OF WORK.
- 8. CONTRACTOR TO PROVIDE PRODUCT'S MANUFACTURING SPECIFICATIONS TO CITY BUILDING DEPARTMENT FOR APPROVED SUBMITTALS TO ALLOW FOR CONSTRUCTION COORDINATION AND TO ENSURE APPROPRIATE DESIGN PRACTICES ARE REVIEWED AND ENFORCED BY THE CITY AND
- 9. THE CONTRACTOR SHALL DISPOSE OF ALL UNSUITABLE MATERIALS, CONSTRUCTION DEBRIS, AND OTHER WASTE MATERIALS OFFSITE IN ACCORDANCE WITH APPLICABLE REGULATORY AGENCY REQUIREMENTS AT THE CONTRACTOR'S EXPENSE. ALL BACKFILL SHALL BE FREE OF UNSUITABLE
- 10. THE CONTRACTOR SHALL BE RESPONSIBLE FOR PROVIDING A HURRICANE PREPARATION PLAN TO THE CITY'S ENGINEERING REPRESENTATIVE FOR REVIEW AND APPROVAL PRIOR TO COMMENCING CONSTRUCTION ACTIVITIES.
- 11. ANY DAMAGE TO CITY, COUNTY, OR STATE ROADS CAUSED BY THE CONTRACTOR SHALL BE REPAIRED BY THE CONTRACTOR IN A TIMELY MANNER AND TO THE SATISFACTION OF THE CITY'S ENGINEERING REPRESENTATIVE. PAYMENT SHALL NOT BE MADE FOR THIS WORK
- 12. THE CONTRACTOR SHALL INSTALL EQUIPMENT IN ACCORDANCE WITH THE APPROVED EQUIPMENT MANUFACTURER'S INSTRUCTIONS AND RECOMMENDATIONS AND APPROVED SUBMITTALS AT THE LOCATIONS SHOWN ON THE DRAWINGS. IF THE EQUIPMENT LOCATION SHOWN ON THE DRAWINGS ARE IN CONFLICT WITH THE MANUFACTURER'S RECOMMENDATIONS OR WILL INTERFERE WITH THE INSTALLATION OF ANY OTHER EXISTING OR INDICATED IN THE CONTRACT DOCUMENTS, THE CONTRACTOR SHALL PROVIDE THE NECESSARY APPURTENANCES TO INSTALL THE EQUIPMENT IN ACCORDANCE WITH THE MANUFACTURER'S RECOMMENDATIONS AT NO ADDITIONAL COST TO THE OWNER. THE CONTRACTOR SHALL NOT INSTALL ANY EQUIPMENT AT LOCATIONS NOT IN ACCORDANCE WITH THE CONTRACT DOCUMENTS OR APPROVED SUBMITTALS UNLESS AUTHORIZED IN WRITING BY THE ENGINEER AND OWNER.
- 13. THE CONTRACTOR SHALL HAVE AVAILABLE AT THE JOB SITE AT ALL TIMES ONE COPY OF THE CONSTRUCTION DOCUMENTS INCLUDING PLANS, SPECIFICATIONS, AND SPECIAL CONDITIONS AND COPIES OF ANY REQUIRED CONSTRUCTION PERMITS.
- 14. THE CONTRACTOR IS RESPONSIBLE FOR PREVENTING AND/OR ABATING ANY SPILLS OF SCREW PUMP CONTENTS, CLEANING WATER OR OTHER LIQUIDS ONTO THE OWNER'S FACILITY SITE.
- 15. THE CONTRACTOR IS RESPONSIBLE TO MAKE SURE THAT THERE ARE NOT SPILLS OF SEWAGE. RECLAIMED WATER, SLUDGE, OR OTHER REGULATED FLUIDS. CONTRACTOR SHOULD MAKE PROVISIONS SUCH AS CATCHMENTS WHEN OPENING PIPES, DEMOLITION, HYDRAULIC TESTING, ETC.
- 16. SPILLS OF ANY NATURE CAUSED BY THE CONTRACTOR SHALL BE CONTROLLED AND CLEANED IMMEDIATELY. ALL SPILLS ONSITE MUST BE RECORDED WITH VOLUME AND ACTIONS TAKEN TO CLEAN AREA AND REPORTED TO THE OWNER, ENGINEER, AND FDEP.
- 17. CONTRACTOR SHALL COVER AND ISOLATE ALL WORK AREAS WITH DISPOSABLE PLASTIC SHEETING AND STRATEGICALLY PLACED DRIP PANS TO PREVENT POSSIBLE CONTAMINATION AND MINIMIZE SPILLS.

EXISTING CONDITIONS

- 18. LOCATIONS, ELEVATIONS, AND DIMENSIONS OF EXISTING UTILITIES, STRUCTURES, AND OTHER FEATURES ARE SHOWN BASED ON THE BEST INFORMATION AVAILABLE AT THE TIME OF PREPARATION OF THESE DRAWINGS BUT ARE NOT PURPORTED TO BE ABSOLUTELY CORRECT. THERE MAY BE OTHER IMPROVEMENTS, UTILITIES, ETC. WHICH ARE WITHIN THE PROJECT AREA. CONTRACTOR SHALL VERIFY, PRIOR TO CONSTRUCTION, THE LOCATIONS, ELEVATIONS, DIMENSIONS, TYPES, AND CONDITIONS OF ALL EXISTING UTILITIES, STRUCTURES, AND OTHER FEATURES (WHETHER OR NOT SHOWN ON THE DRAWINGS) AFFECTING HIS WORK.
- 19. PRIOR TO SHOP DRAWING PREPARATION AND SUBMITTAL AND PURCHASE OF RELATED MATERIALS, THE CONTRACTOR SHALL FIELD VERIFY EXISTING UTILITIES (LOCATION, SIZE, MATERIALS OF CONSTRUCTION, OUTSIDE DIAMETER, WALL THICKNESS, ROUNDNESS, ELEVATIONS, ETC.) TO WHICH CONNECTION(S) WILL BE MADE. CONTRACTOR SHALL INCLUDE FIELD MEASUREMENTS ON SHOP
- 20. THE CONTRACTOR SHALL NOTIFY THE OWNER AND ENGINEER IN WRITING IMMEDIATELY IF CONFLICTS BETWEEN THE DRAWINGS AND ACTUAL CONDITIONS ARE DISCOVERED. THE CONTRACTOR SHALL ACCURATELY RECORD ANY SUCH CONFLICTS ON THE RECORD DRAWINGS.
- 21. ANY PROPERTY CORNERS, MONUMENTS, OR BENCH MARKS WITHIN THE PROJECT AREA SHALL BE PROTECTED UNLESS OTHERWISE INDICATED FOR DEMOLITION. IF ANY SUCH ITEMS ARE IN DANGER OF DAMAGE OR HAVE BEEN DAMAGED, THE CONTRACTOR SHALL NOTIFY THE OWNER AND THE ENGINEER IMMEDIATELY AND REPLACE/RESTORE THESE ITEMS AT NO ADDITIONAL COST TO THE OWNER. IF THE OWNER CHOOSES TO SELF PERFORM THE WORK OR INCURS RELATED EXPENSES, THE COSTS SHALL BE DEDUCTED FROM THE CONTRACT PRICE.
- 22. MATERIALS INTERFERING WITH CONSTRUCTION MAY BE DEMOLISHED IF APPROVED BY THE OWNER AND ENGINEER, AND DISPOSED OF AS DIRECTED BY THE CITY'S ENGINEERING REPRESENTATIVE, UNLESS OTHERWISE NOTED ON PLANS.

UTILITY COORDINATION

- 23. THE CONTRACTOR SHALL PRESERVE AND MAINTAIN EXISTING UTILITIES, STRUCTURES, AND OTHER FEATURES WITHIN THE PROJECT AREA. ANY DAMAGE SHALL BE REPAIRED BY AND AT THE EXPENSE OF THE CONTRACTOR TO THE SATISFACTION OF THE OWNER.
- 24. THE CONTRACTOR IS RESPONSIBLE FOR BRACING, SHORING, OR PROVIDING OTHER MEANS NECESSARY TO PROTECT AND SUPPORT EXISTING UTILITIES, STRUCTURES, AND OTHER FEATURES (EXPOSED OR UNEXPOSED) THAT MAY BE IMPACTED BY HIS WORK.
- 25. THE CONTRACTOR SHALL BE RESPONSIBLE FOR TESTING OF ALL NEWLY CONSTRUCTED UTILITIES IN ACCORDANCE WITH CURRENT STANDARDS OF LOCAL JURISDICTION. THE CONTRACTOR SHALL NOTIFY THE LOCAL JURISDICTION AND THE OWNER OR AN AUTHORIZED REPRESENTATIVE AT LEAST FORTY EIGHT (48) HOURS IN ADVANCE OF PERFORMING TESTS.

- 26. IT IS THE RESPONSIBILITY OF THE CONTRACTOR TO BE FAMILIAR WITH THE OSHA EXCAVATION SAFETY STANDARDS AND TO ABIDE BY THEM AS COVERED UNDER THE FLORIDA TRENCH SAFETY
- 27. THE CONTRACTOR SHALL BE SOLELY RESPONSIBLE FOR CONSTRUCTION SAFETY.
- 28. THESE DRAWINGS DO NOT INCLUDE NECESSARY COMPONENTS FOR CONSTRUCTION SAFETY. THE CONTRACTOR IS SOLELY RESPONSIBLE FOR CONSTRUCTION SAFETY. SPECIAL PRECAUTIONS MAY BE REQUIRED IN THE VICINITY OF POWER LINES AND OTHER UTILITIES.

- 29. ALL PAVING, STABILIZED EARTH, DRIVEWAYS, CURBS, SIDEWALKS, FENCES, SOD, LANDSCAPING, CULVERTS. ETC. DISTURBED BY CONSTRUCTION ACTIVITIES SHALL BE RESTORED BY AND AT THE EXPENSE OF THE CONTRACTOR TO THE SATISFACTION OF THE OWNER AND IN ACCORDANCE WITH THE CONTRACT DOCUMENTS
- 30. THE CONTRACTOR SHALL RESTORE EXISTING DRAINAGE PATTERNS DISTURBED BY CONSTRUCTION ACTIVITIES. FINAL GRADING SHALL PROVIDE FOR PROPER DRAINAGE WITH NO PONDING OF WATER.
- 31. A REGISTERED LAND SURVEYOR, AT THE CONTRACTOR'S EXPENSE, SHALL RESET ALL SECTION CORNERS OR PROPERTY CORNERS DISLOCATED OR DISTURBED BY ANY CONSTRUCTION RELATED
- 32. UNLESS NOTED ON THE PLANS, FINAL GRADE IS TO GENERALLY BE THE SAME AS EXISTING GRADE. RESTORE UNIFORMLY AND FOR PROPER YARD DRAINAGE GRADE TOWARD ROADWAY.
- 33. ALL EXCESS SOIL RESULTING FROM CONSTRUCTION ACTIVITIES THAT IS NOT CLAIMED BY THE OWNER SHALL BECOME THE PROPERTY OF THE CONTRACTOR AND DISPOSED OF BY THE
- 34. ALL DISTURBED LANDSCAPED AND/OR GRASSED AREAS SHALL BE RESTORED UNIFORMLY AND BE GENERALLY AT THE SAME ELEVATION AS EXISTING GRADES.
- 35. ALL DISTURBED AREAS SHALL BE REPLACED WITHIN FIFTEEN (15) DAYS TO A CONDITION EQUAL TO OR BETTER THAN EXISTING CONDITIONS.
- 36. ALL VOIDS AFTER PLACEMENT OF SOD SHALL BE FILLED WITH PREPARED SOIL MIX. THE SOD SHALL BE ROLLED TO MEET THE PROPOSED GRADES. SOD PLACED ON SLOPES 3:1 OR STEEPER
- 37. AREAS OF EXPOSED EARTH RESULTING FROM CONSTRUCTION SHALL BE SODDED IN KIND AS DIRECTED BY THE CITY'S ENGINEERING REPRESENTATIVE UNLESS OTHERWISE NOTED ON PLANS.

ACCESS / MAINTENANCE OF FACILITIES

- 38. THE CONTRACTOR SHALL PROVIDE ACCESS TO ALL EXISTING UTILITIES/FACILITIES AND MAINTAIN UNINTERRUPTED SERVICES THROUGHOUT THE CONTRACT PERIOD.
- 39. THE CONTRACTOR SHALL COORDINATE WITH WRF OPERATOR TO ENSURE FACILITIES REMAIN IN OPERATION. IN THE EVENT FACILITIES MUST BE SHUT DOWN, THE CONTRACTOR SHALL COORDINATE WITH THE WRF OPERATOR IN ACCORDANCE WITH SPECIFICATIONS.

MAINTENANCE OF TRAFFIC

- 40. THE CONTRACTOR SHALL FURNISH, ERECT AND MAINTAIN ALL NECESSARY TRAFFIC CONTROL AND SAFETY DEVICES IN ACCORDANCE WITH THE U.S. DEPARTMENT OF TRANSPORTATION, "MANUAL ON UNIFORM TRAFFIC CONTROL DEVICES" AND THE LATEST FLORIDA DEPARTMENT OF TRANSPORTATION "DESIGN STANDARDS"
- 41. THE CONTRACTOR SHALL PROVIDE, ERECT AND MAINTAIN EFFECTIVE BARRICADES, DANGER SIGNALS SIGNS AND PEDESTRIAN DETOURS IN ALL AREAS WHERE REQUIRED FOR THE PROTECTION OF THE WORK AND THE SAFETY OF THE PUBLIC.
- 42. MAINTENANCE OF TRAFFIC (MOT): IF IT BECOMES NECESSARY FOR THE CONTRACTOR TO CLOSE ANY STREETS OR PLANT ROADS TO THROUGH TRAFFIC WITHIN THE LIMITS OF CONSTRUCTION, MAINTENANCE OF TRAFFIC SHALL BE IN ACCORDANCE WITH THE CITY OF CLEARWATER STANDARDS. IF THE CONSTRUCTION OPERATIONS CAUSE TRAFFIC HAZARDS, REPAIR THE ROAD SURFACE, PROVIDE TEMPORARY WAYS, ERECT WHEEL GUARDS OR FENCES, OR TAKE MEASURES FOR SAFETY SATISFACTORY TO THE ENGINEER OR ONSITE DELIVERIES TO STILL TAKE PLACE. DETOURS AROUND THE CONSTRUCTION WILL BE SUBJECT TO THE APPROVAL OF THE OWNER AND ENGINEER.
- 43. DELIVERIES OF CONSTRUCTION MATERIALS AND EQUIPMENT SHALL BE SCHEDULED TO OCCUR IN TIMEFRAMES DURING OFF-PEAK HOURS OF THE ROADWAYS NEAR AND AROUND THE WRF SITE.
- 44. CONTRACTOR TO PREPARE AND SUBMIT MAINTENANCE OF TRAFFIC (MOT) PLAN IN ACCORDANCE WITH FDOT STANDARDS FOR CONSTRUCTION VEHICLES ENTERING AND EXITING THE WRF ON SR60. CONTRACTOR SHALL COORDINATE WITH FDOT FOR PLACEMENT OF MOT SIGNAGE AND OTHER DEVICES IN THE FDOT ROW AND PROVIDE DOCUMENTATION OF THE COORDINATION. THE MOT PLAN SHALL BE SUBMITTED TO THE OWNER (CITY), CITY BUILDING DEPARTMENT, AND ENGINEER FOR
- 45. CONTRACTOR SHALL COORDINATE WITH THE OWNER AND CHIEF WRF OPERATIONS PERSONNEL FOR DELIVERIES AND OFFLOADING DURING ANTICIPATED OR KNOWN PERIODS WHEN INCOMING, OUTGOING, AND INTERNAL OPERATIONS TRAFFIC IS HIGH TO PREVENT INTERRUPTIONS AND DELAYS OF THE NORMAL OPERATIONS AND MAINTENANCE OF THE WRF.
- 46. CONTRACTOR SHALL FURNISH AND PLACE TEMPORARY DIRECTIONAL AND TRAFFIC SIGNS INSIDE THE WRF TO PROVIDE A ROUTE TO THE CONSTRUCTION SITE FROM THE WRF THAT IS IN COORDINATION WITH THE WRF OPERATION STAFF AND DOES NOT INTERFERE WITH NORMAL OPERATIONS OF THE

EROSION CONTROL AND DRAINAGE

- 47. THE CONTRACTOR SHALL INSTALL FILTER FABRIC OVER ALL NEARBY AND POTENTIALLY IMPACTED DRAINAGE STRUCTURES FOR THE DURATION OF CONSTRUCTION AND UNTIL ACCEPTANCE OF THE PROJECT BY THE OWNER. ALL NEARBY AND IMPACTED DRAINAGE STRUCTURES SHALL BE CLEANED OF DEBRIS AS REQUIRED DURING AND AT THE END OF CONSTRUCTION TO PROVIDE POSITIVE DRAINAGE FLOWS.
- 48. ALL SLOPES AND AREAS DISTURBED BY CONSTRUCTION SHALL BE GRADED TO RESTORE PRE-CONSTRUCTION DRAINAGE FEATURES. THE AREAS SHALL THEN BE SODDED AS SPECIFIED, FERTILIZED, AND MAINTAINED UNTIL HARDY GRASS GROWTH IS ESTABLISHED IN ALL AREAS. SOD SHALL MATCH EXISTING TURF. ANY AREAS DISTURBED FOR ANY REASON PRIOR TO FINAL ACCEPTANCE OF THE JOB SHALL BE CORRECTED BY THE CONTRACTOR AT NO ADDITIONAL COST TO THE OWNER. ALL EARTHEN AREAS WILL BE SODDED AND MULCHED.
- 49. THE CONTRACTOR SHALL BE RESPONSIBLE FOR THE CONTROL OF DUST AND DIRT RISING AND SCATTERING IN THE AIR DURING CONSTRUCTION AND SHALL PROVIDE WATER SPRINKLING OR OTHER SUITABLE METHODS OF CONTROL. THE CONTRACTOR SHALL COMPLY WITH ALL GOVERNING REGULATIONS PERTAINING TO ENVIRONMENTAL PROTECTION.
- 50. THE CONTRACTOR SHALL TAKE ALL REQUIRED MEASURES TO CONTROL TURBIDITY, INCLUDING BUT NOT LIMITED TO THE INSTALLATION OF TURBIDITY BARRIERS AT ALL LOCATIONS WHERE THE POSSIBILITY OF TRANSFERRING SUSPENDED SOLIDS INTO THE RECEIVING WATER BODY EXISTS DUE TO THE PROPOSED WORK. TURBIDITY BARRIERS MUST BE MAINTAINED IN EFFECTIVE CONDITION AT ALL LOCATIONS UNTIL CONSTRUCTION IS COMPLETED AND DISTURBED SOIL AREAS ARE STABILIZED. THEREAFTER, THE CONTRACTOR MUST REMOVE THE BARRIERS. AT NO TIME SHALL THERE BE ANY OFF-SITE DISCHARGE WHICH VIOLATES STATE WATER QUALITY STANDARDS.
- 51. THE CONTRACTOR SHALL TAKE ALL REQUIRED MEASURES TO CONTROL EROSION AND TRANSPORT OF SEDIMENTS WITHIN AND FROM THE PROJECT AREA, SO AS TO PREVENT THE DEGRADATION OF RECEIVING WATERS, DETRIMENTAL EFFECTS ON PUBLIC OR PRIVATE PROPERTY ADJACENT TO THE PROJECT AND DAMAGE WITHIN THE PROJECT AREA. THESE MEASURES WILL INCLUDE THE CONSTRUCTION AND MAINTENANCE OF TEMPORARY AND PERMANENT EROSION CONTROLS.
- 52. MONITORING OF OFFSITE TRACKING OF SEDIMENTS AT THE ENTRANCES IS REQUIRED WHERE SILT FENCE WILL NOT BE PLACED TO ENABLE ACCESS TO THE SITE. IF IT APPEARS THAT SIGNIFICANT AMOUNTS OF SEDIMENT ARE BEING TRACKED OFF THE SITE, THEN THE CONTRACTOR SHALL CONSTRUCT GRAVEL ENTRANCES OR OTHER EQUIVALENT MEASURES TO HELP DISLODGE THE SOIL, SEDIMENT AND DIRT BEFORE THE VEHICLES LEAVE THE SITE.
- 53. AREAS WHERE THE GROUND HAS BEEN DISTURBED AND CONSTRUCTION ACTIVITIES TEMPORARILY WILL CEASE FOR MORE THAN 21 DAYS SHALL BE STABILIZED WITH A TEMPORARY SEED AND MULCH WITHIN 7 DAYS OF THE LAST DISTURBANCE. ONCE CONSTRUCTION ACTIVITY CEASES PERMANENTLY IN AN AREA WHERE THE GROUND HAS BEEN DISTURBED, THAT AREA SHALL BE STABILIZED WITH SOD OR OTHER SUITABLE STABILIZATION MATERIALS. AFTER THE SITE IS STABILIZED, ALL EXCESS SEDIMENTS AND DEBRIS SHALL BE REMOVED FROM THE PONDS AND STORMWATER CONVEYANCE SYSTEM/STRUCTURES RECEIVING DIRECT RUNOFF FROM THE AREA.
- 54. IT IS THE RESPONSIBILITY OF THE CONTRACTOR TO CONTROL AND PREVENT EROSION AND THE TRANSPORTATION OF SEDIMENT TO SURFACE DRAINS AND OUTFALLS.
- 55. THE CONTRACTOR SHALL PREPARE AND SUBMIT A STORMWATER POLLUTION PREVENTION PLAN (SWPPP) IN ACCORDANCE WITH FLORIDA DEPARTMENT OF ENVIRONMENTAL PROTECTION (FDEP) CRITERIA FOR A NATIONAL POLLUTION DISCHARGE ELIMINATION SYSTEM (NPDES) ACTIVITIES PERMIT.
- 56. CONSTRUCTION OPERATIONS SHALL BE CARRIED OUT IN SUCH A MANNER THAT EROSION AND POLLUTION SHALL BE MINIMIZED. THE SUBMITTED SWPPP SHALL BE COMPLIED WITH. ALL APPLICABLE FEDERAL, STATE, AND LOCAL LAWS SHALL BE COMPLIED WITH AT ALL TIMES. PLEASE NOTE THAT NO HAY BALES ARE ALLOWED ON CITY OF CLEARWATER PROJECTS.

BID DOCUMENTS

DATE

RECORD DRAWINGS SURVEYED BY: DRAWN BY: REVIEWED BY: PPROVED BY: REVISION CITY ENGINEER, PUBLIC WORKS TARA KIVETT, P.E. #86611 DATE DATE

CITY OF CLEARWATER, FLORIDA ENGINEERING DEPARTMENT 100 SOUTH MYRTLE AVENUE CLEARWATER, FL 33756





EAST WRF SCREW PUMP REPLACEMENT

GENERAL NOTES


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0372006201-G02.DWG VERT. OCTOBER 2023 JKRAMER HORIZ **AHOLMES** ZSPLAYT APPROVED FOR CONSTRUCTION


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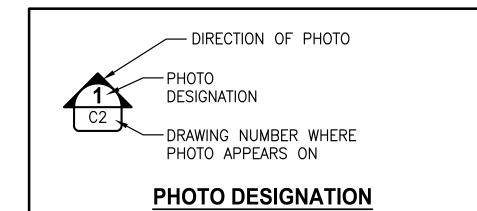
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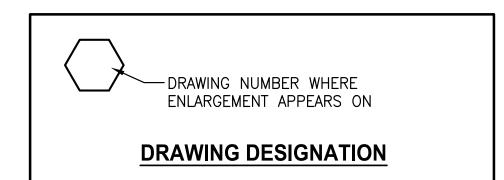
SECTION DESIGNATION



SECTION DESIGNATION



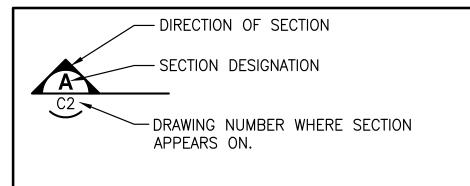

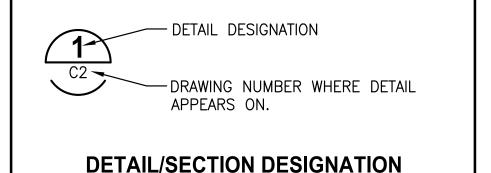

CUSTOM ABBREVIATIONS

PS PUMP STATION
WRF WATER RECLAMATION FACILITY

ST

ST

STA

STD

STL

STS

SW

SWD

SWJ

SY

T/

TBM

TEMP

TGS

TH

THD

TJB

ΤK

TOC

TOS

TOSJ

TOW

TS

TSF

TSP

TYP

UG

UL

ULC

UNO

UPS

VERT

VFD

VH

VIF

W/

WF

WP

WGT

WSE

WSEL

XFMR

W/O

TURB

T, THK

T/B,T&B

SHUNT TRIP

STREET

STATION

STEEL

THICK

TOP OF

STANDARD

STORMWATER SEWER

SOUTH WEST, SWITCH

SOLVENT WELD JOINT

STORM WATER POLLUTION PREVENTION PLAN

SIDE WATER DEPTH

SQUARE YARD

TOP AND BOTTOM

TEMPERATURE

TOTAL HEAD

THREADED

TANK

TEMPORARY BENCHMARK

TERMINAL JUNCTION BOX

THICKENED SLAB FOOTING

UNDERWRITER'S LABORATORIES

UNLESS NOTED OTHERWISE

VARIABLE FREQUENCY DRIVE

ULTRASONIC LEVEL CONTROLLER

UNINTERRUPTIBLE POWER SUPPLY

TWISTED SHIELDED PAIR

TOP OF CONCRETE

TOP OF STEEL JOIST

TOP OF STEEL

TOP OF WALL

TURBIDITY

TYPICAL

VERTICAL

VIBRATION

VAPORIZER

WIDE, WATT

WITHOUT

WFIGHT

WEIGHT

WATER VALVE

TRANSFORMER

EXTRA STRONG

WELDED WIRE FABRIC

WITH

TUBULAR STEEL

UNDERGROUND

VOLTAGE, VOLTS

VAPOR HEATER

VERIFY IN FIELD

WALL CONTROL JOINT

WORK POINT, WEATHERPROOF

WATER SURFACE ELEVATION

WALL FOOTING

THREADED GALVANIZED STEEL

THREADED GALVANIZED STEEL PIPE

BID DOCUMENTS

DATE

RECORD DRAWINGS

SURVEYED BY:

PROJECT ENGINEER

DATE

OTHER PROJECT ENGINEER

SUNSHINE STATE
ONE CALL
OF FLORIDA
www.sunshine811.com
(800) 432-4770
MIN. 48 HOUSE

Jones Edmunds

730 NE WALDO ROAD, GAINESVILLE, FLORIDA 32641 / (352) 377-5821
324 S. HYDE PARK AVE., SUITE 250 TAMPA, FLORIDA 33606 / (813) 258-0703

EAST WRF
SCREW PUMP REPLACEMENT

ABBREVIATIONS AND

DESIGNATIONS

MENT

CONTRACT NO.:

JOB NO.:

APPROVED FOR CONSTRUCTION

DWG NAME:
0372006201-G03.DWG

CONTRACT NO.:

DATE DRAWN:
OCTOBER 2023

JKRAMER

HORIZ.

JOB NO.:

DESIGNED BY:
ZSPLAYT

APPROVED FOR CONSTRUCTION

SCALE:
VERT.


CHECKED BY:
CHECKED BY:
AHOLMES


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VERT.

CHECKED BY:
AHOLMES

SCALE:
VERT.

AHOLMES

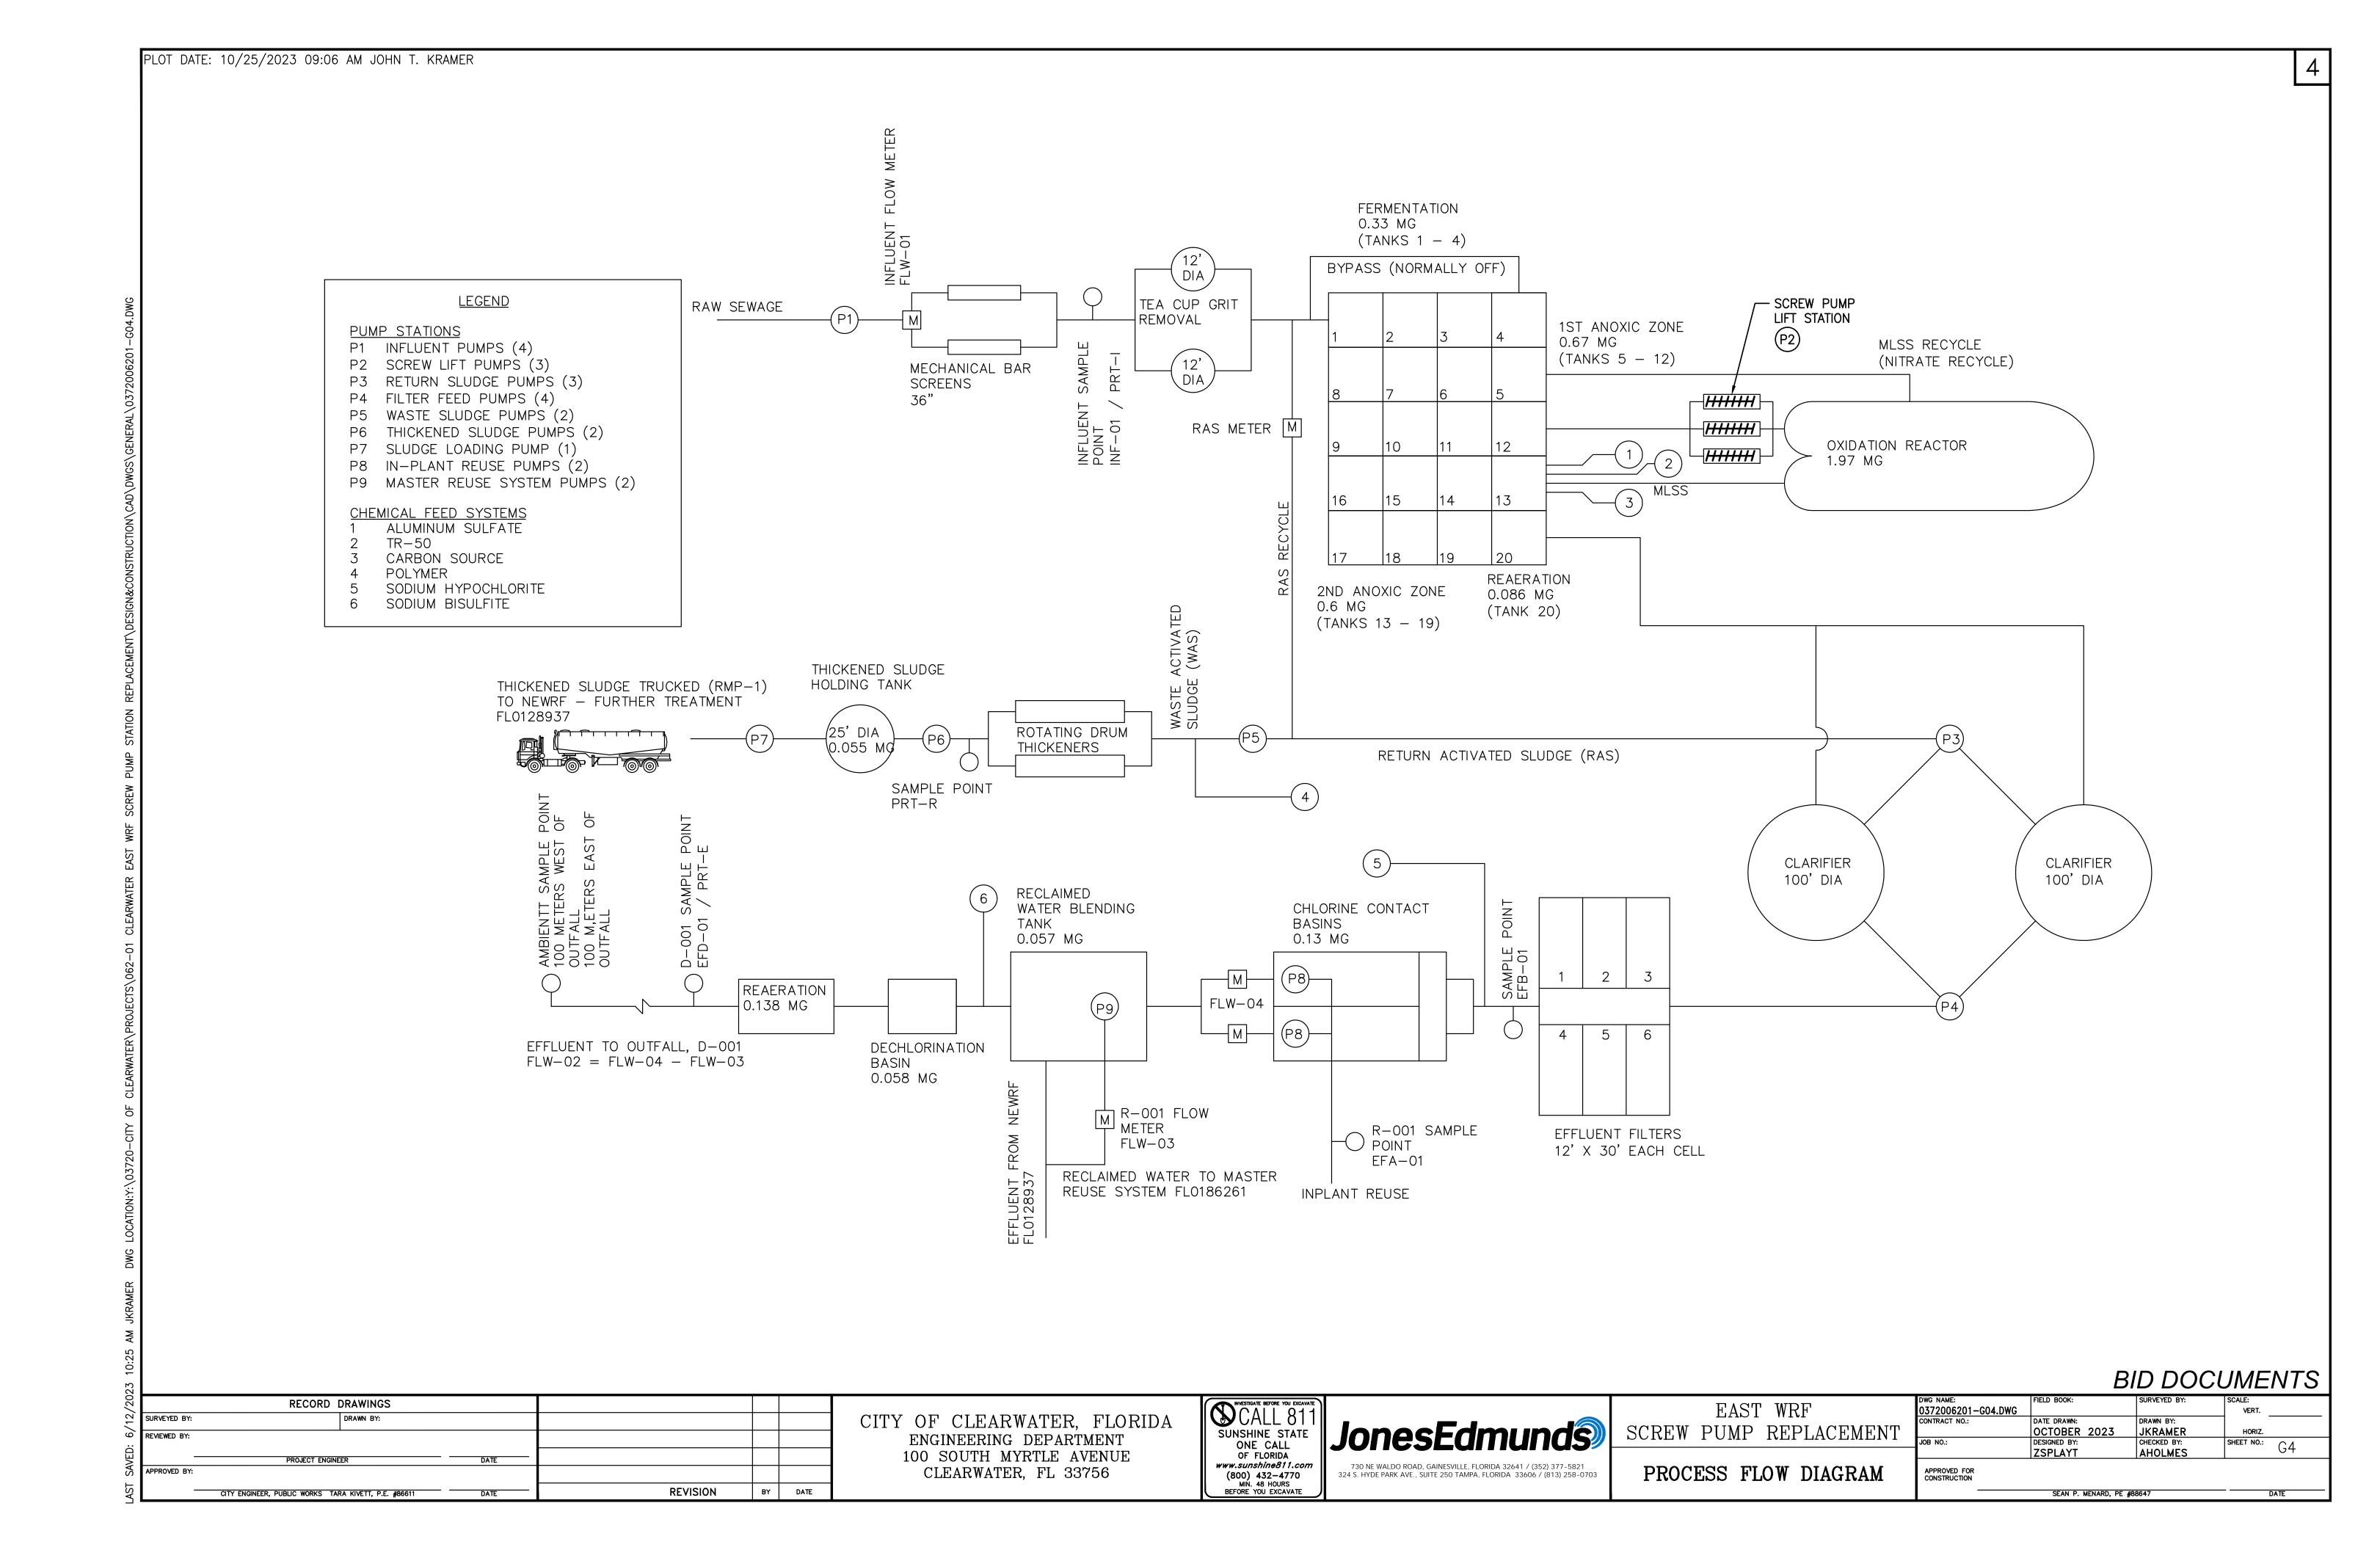

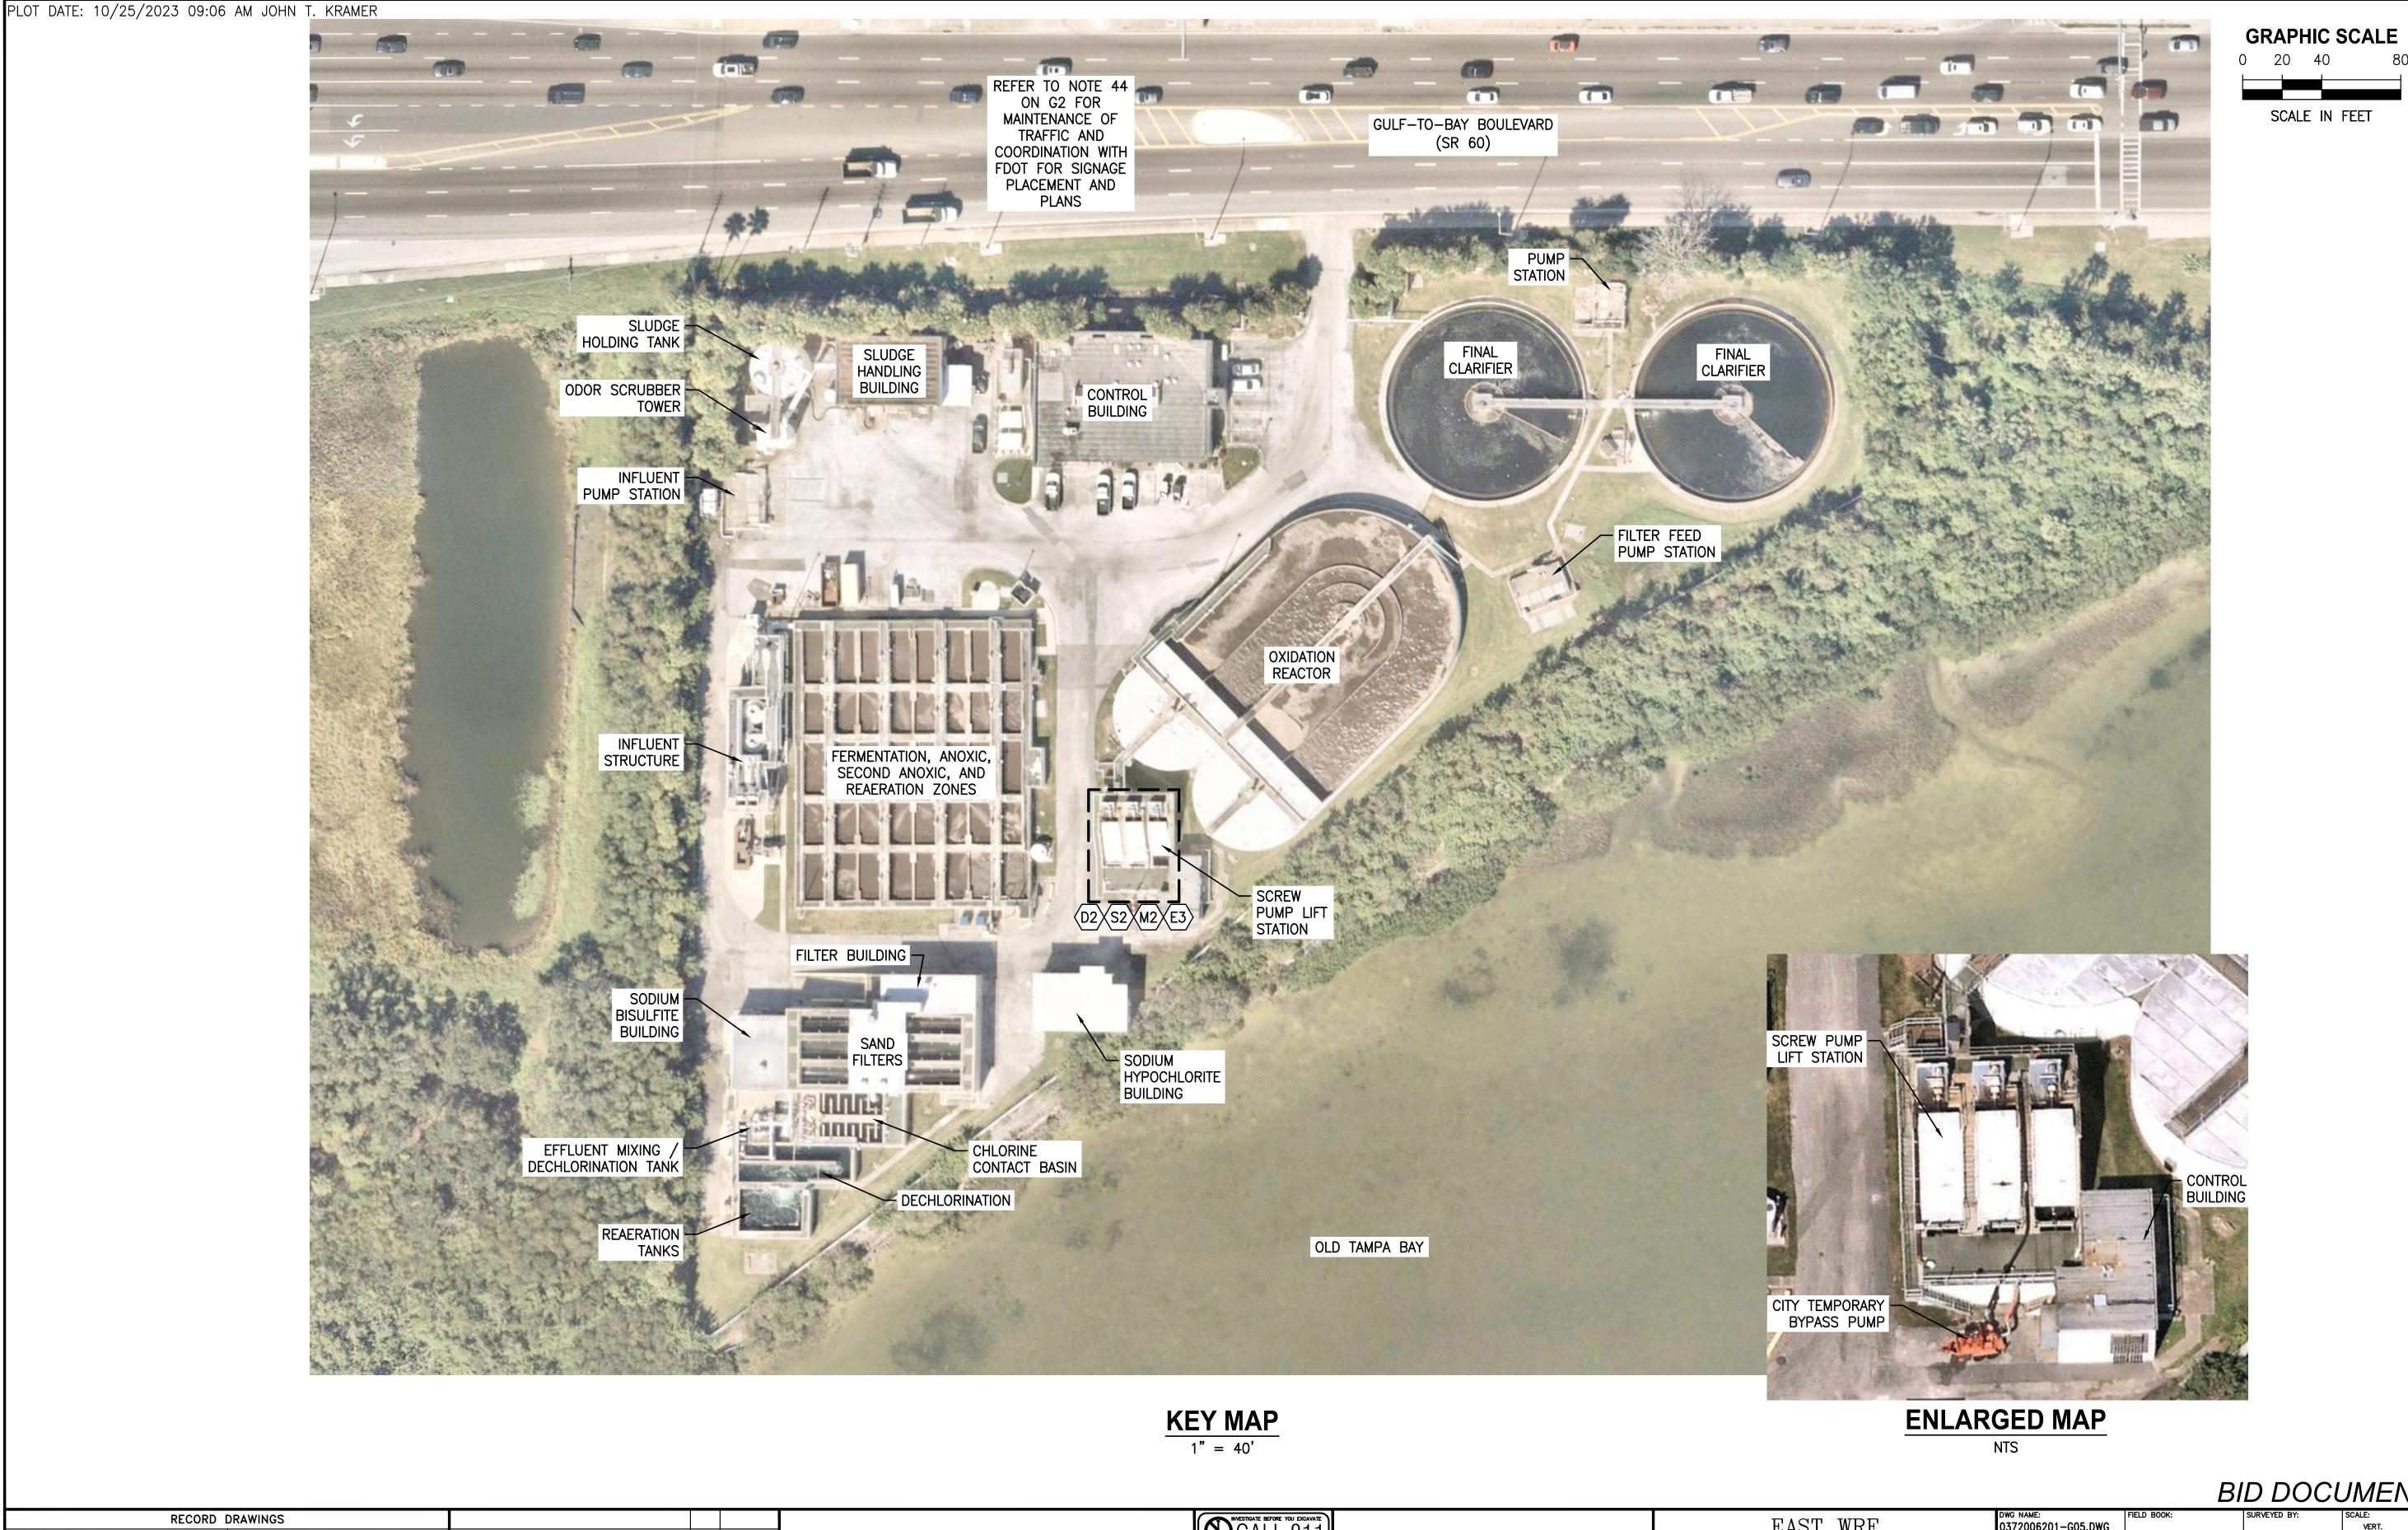

BID DOCUMENTS

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OF FLORIDA

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EAST WRF SCREW PUMP REPLACEMENT

DWG NAME: 0372006201-G05.DWG CONTRACT NO.: DATE DRAWN:
OCTOBER 2023
DESIGNED BY:
ZSPLAYT JKRAMER CHECKED BY: AHOLMES G5 APPROVED FOR CONSTRUCTION

SURVEYED BY: REVIEWED BY: APPROVED BY: REVISION CITY ENGINEER, PUBLIC WORKS TARA KIVETT, P.E. #86611

CITY OF CLEARWATER, FLORIDA ENGINEERING DEPARTMENT 100 SOUTH MYRTLE AVENUE CLEARWATER, FL 33756

KEY MAP

LEGEND:

DEMOLISH AND REMOVE

TO BE PROTECTED AND/OR RELOCATED

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TO BE REFURBISHED

RECORD DRAWINGS

SURVEYED BY:

PROJECT ENGINEER

DATE

APPROVED BY:

CITY ENGINEER, PUBLIC WORKS TARA KIVETT, P.E. #86611

DATE

REVIEWED BY:

REVIEWED BY:

REVIEWED BY:

REVISION

REVISION

REVISION

BY DATE

CITY OF CLEARWATER, FLORIDA ENGINEERING DEPARTMENT 100 SOUTH MYRTLE AVENUE CLEARWATER, FL 33756





EAST WRF
SCREW PUMP REPLACEMENT

DEMOLITION NOTES AND LEGEND

DWG NAME:
0372006201-D01.DWG

CONTRACT NO.:

DATE DRAWN:
OCTOBER 2023

JKRAMER

HORIZ.

JOB NO.:

DESIGNED BY:
ZSPLAYT

APPROVED FOR CONSTRUCTION

DIAMON BY:
APPROVED FOR CONSTRUCTION

DESIGNED BY:
APPROVED FOR CONSTRUCTION

SURVEYED BY:
VERT.

VERT.

VERT.

VERT.

VERT.

VERT.

ACHECKED BY:
AHOLMES

D1

SEAN P. MENARD, PE #88647

DEMOLITION NOTES:

- 1. ALL DEMOLISHED STRUCTURES, EQUIPMENT, ELECTRICAL, PIPING, CONCRETE AND OTHER APPURTENANCES ARE TO BE REMOVED FROM SITE AND PROPERLY DISPOSED OF IN A LEGAL MANNER.
- 2. CONTRACTOR TO COORDINATE DEMOLITION WITH CONTRACT DOCUMENTS IN GENERAL AND SPECIFICALLY SECTION 01100, SUMMARY OF WORK; SECTION 01815, MAINTENANCE OF PLANT OPERATION AND SEQUENCE OF CONSTRUCTION; AND SECTION 02200, DEMOLITION AND MODIFICATIONS.
- 3. UNLESS OTHERWISE NOTED, ALL DEMOLISHED BUILDINGS, STRUCTURE, SLABS, CONCRETE, ASPHALT, DEBRIS PILES, SIGNS, AND ALL APPURTENANCES ARE TO BE REMOVED FROM THE SITE BY THE CONTRACTOR AND PROPERLY DISPOSED OF IN A LEGAL MANNER AS PART OF THIS CONTRACT. SOME ITEMS TO BE REMOVED MAY NOT BE DEPICTED ON THE TOPOGRAPHIC SURVEY. CONFIRM THAT REGULATED TOXIC/HAZARDOUS WASTES OR MATERIALS ARE NOT PRESENT OR WILL BE PROPERLY MANAGED DURING THE DEMOLITION PROCESS. IT IS THE CONTRACTOR'S RESPONSIBILITY TO VISIT THE SITE AND DETERMINE THE FULL EXTENT OF ITEMS TO BE REMOVED. IF ANY ITEMS ARE IN QUESTION, THE CONTRACTOR SHALL CONTACT THE OWNER PRIOR TO REMOVAL OF SAID ITEMS.
- 4. THE DEFINITION OF DEMOLITION SHALL INCLUDE REMOVAL AND PROPER DISPOSAL OF FACILITIES, UTILITIES, STRUCTURES, AND THEIR ASSOCIATED APPURTENANCES. DEMOLITION SHALL NOT BE CONSIDERED TO INCLUDE ABANDON—IN—PLACE. ITEMS TO BE ABANDONED—IN—PLACE WILL BE INDICATED AS SUCH.
- 5. DEMOLITION MATERIALS SHALL INCLUDE ALL DEBRIS, MATERIALS, GRIT, MUD, SLUDGE, AND WATER. THE CONTRACTOR SHALL COLLECT AND HAUL OFF ALL DEMOLITION MATERIALS FOR PROPER DISPOSAL OFF—SITE.
- 6. NOT ALL UTILITIES MAY BE SHOWN IN THE DRAWINGS. THE CONTRACTOR SHALL BE COGNIZANT OF OBSTRUCTIONS/UTILITIES THAT AFFECT WORK. UTILITY LOCATES SHALL BE PERFORMED WITHIN FIVE FEET OF ALL AREAS TO BE DISTURBED AND CONTINUOUSLY WITHIN FIVE FEET OF ALL BUILDINGS AND STRUCTURES TO BE DEMOLISHED. CONTRACTOR SHALL NOTIFY ENGINEER IF VARYING SITE CONDITIONS ARE FOUND.
- 7. DIMENSIONS SHOWN ON THE DRAWINGS ARE APPROXIMATE; HOWEVER, THE CONTRACTOR IS SOLELY RESPONSIBLE FOR DETERMINING ALL MATERIAL QUANTITIES PRIOR TO BIDDING.
- 8. CONTRACTOR SHALL NOT COMMENCE DEMOLITION WORK UNTIL ALL UTILITIES HAVE BEEN VERIFIED TO BE DISCONNECTED AND ISOLATED. COORDINATE WITH ENGINEER AND OWNER FOR VERIFICATION OF LOCKOUT TAG OUT AND DISCONNECTION OF ALL SYSTEMS. DO NOT DEMOLISH ANY ELECTRICAL AND COMMUNICATION EQUIPMENT UNTIL IT HAS BEEN DE-ENERGIZED COMPLETELY, DISCONNECTED AND VERIFIED DE-ENERGIZED. UTILITIES TO REMAIN IN SERVICE UNLESS INTERRUPTION IS UNAVOIDABLE MAY TEMPORARILY BE TAKEN OUT OF SERVICE BY OBTAINING PRIOR APPROVAL FROM OWNER.
- 9. FACILITIES AND IMPROVEMENTS TO REMAIN SHALL BE CLEANED OF DUST, DIRT, AND DEBRIS CAUSED BY DEMOLITION OPERATIONS. RETURN ADJACENT AREAS TO PRE—CONSTRUCTION CONDITIONS BY PROJECT COMPLETION.
- 10. THE CONTRACTOR SHALL PROTECT EXISTING EQUIPMENT, SURFACES AND STRUCTURES TO REMAIN INSIDE AND OUTSIDE THE LIMITS OF DEMOLITION. THE CONTRACTOR SHALL BE RESPONSIBLE FOR REPAIRING TO PRE-DEMOLITION CONDITIONS ANY DAMAGE TO EXISTING EQUIPMENT, SURFACES, UTILITIES, STRUCTURES, AND OTHER FEATURES CAUSED BY DEMOLITION ACTIVITIES, AT NO ADDITIONAL COST TO THE OWNER.
- 11. THE CONTRACTOR SHALL BE RESPONSIBLE FOR BRACING, SHORING, OR PROVIDING OTHER MEANS NECESSARY TO PROTECT AND SUPPORT EXISTING UTILITIES AND STRUCTURES DURING CONSTRUCTION/DEMOLITION.
- 12. CONTRACTOR SHALL PREVENT THE DISCHARGE OF SEDIMENT INTO DRAINAGE DITCHES OR TRENCHES DUE TO DEMOLITION OPERATIONS. APPROVED EROSION CONTROL DEVICES SHALL BE INSTALLED TO PREVENT DISCHARGE OF SEDIMENT INTO A DRY OR WET WATERCOURSE. EROSION CONTROL SHALL CONSIST OF MULCH AND NETTING, FILTER CLOTH BARRIERS OR OTHER EROSION CONTROL METHODS APPROVED BY THE COUNTY.
- 13. ALL CONSTRUCTION AND DEMOLITION DEBRIS SHALL BE REMOVED FROM THE PROJECT SITES BY THE CONTRACTOR WITHIN ONE WEEK OF REMOVAL FROM THE STRUCTURE OR ORIGINAL PLACE OF ORIGIN, UNLESS OTHERWISE APPROVED BY THE COUNTY.

RECORD DRAWINGS

SURVEYED BY:

PROJECT ENGINEER

DATE

CITY ENGINEER, PUBLIC WORKS TARA KIVETT, P.E. #86611

DATE

CITY OF CLEARWATER, FLORIDA ENGINEERING DEPARTMENT 100 SOUTH MYRTLE AVENUE CLEARWATER, FL 33756

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EAST WRF

SCREW PUMP REPLACEMENT

DEMOLITION PLAN

APPR CONS

DWG NAME:

0372006201-D02.DWG

CONTRACT NO.:

DATE DRAWN:
OCTOBER 2023

DESIGNED BY:
ZSPLAYT


APPROVED FOR CONSTRUCTION

SURVEYED BY:
VERT.

DRAWN BY:
HORIZ.

SHEET NO.:

APPROVED FOR CONSTRUCTION

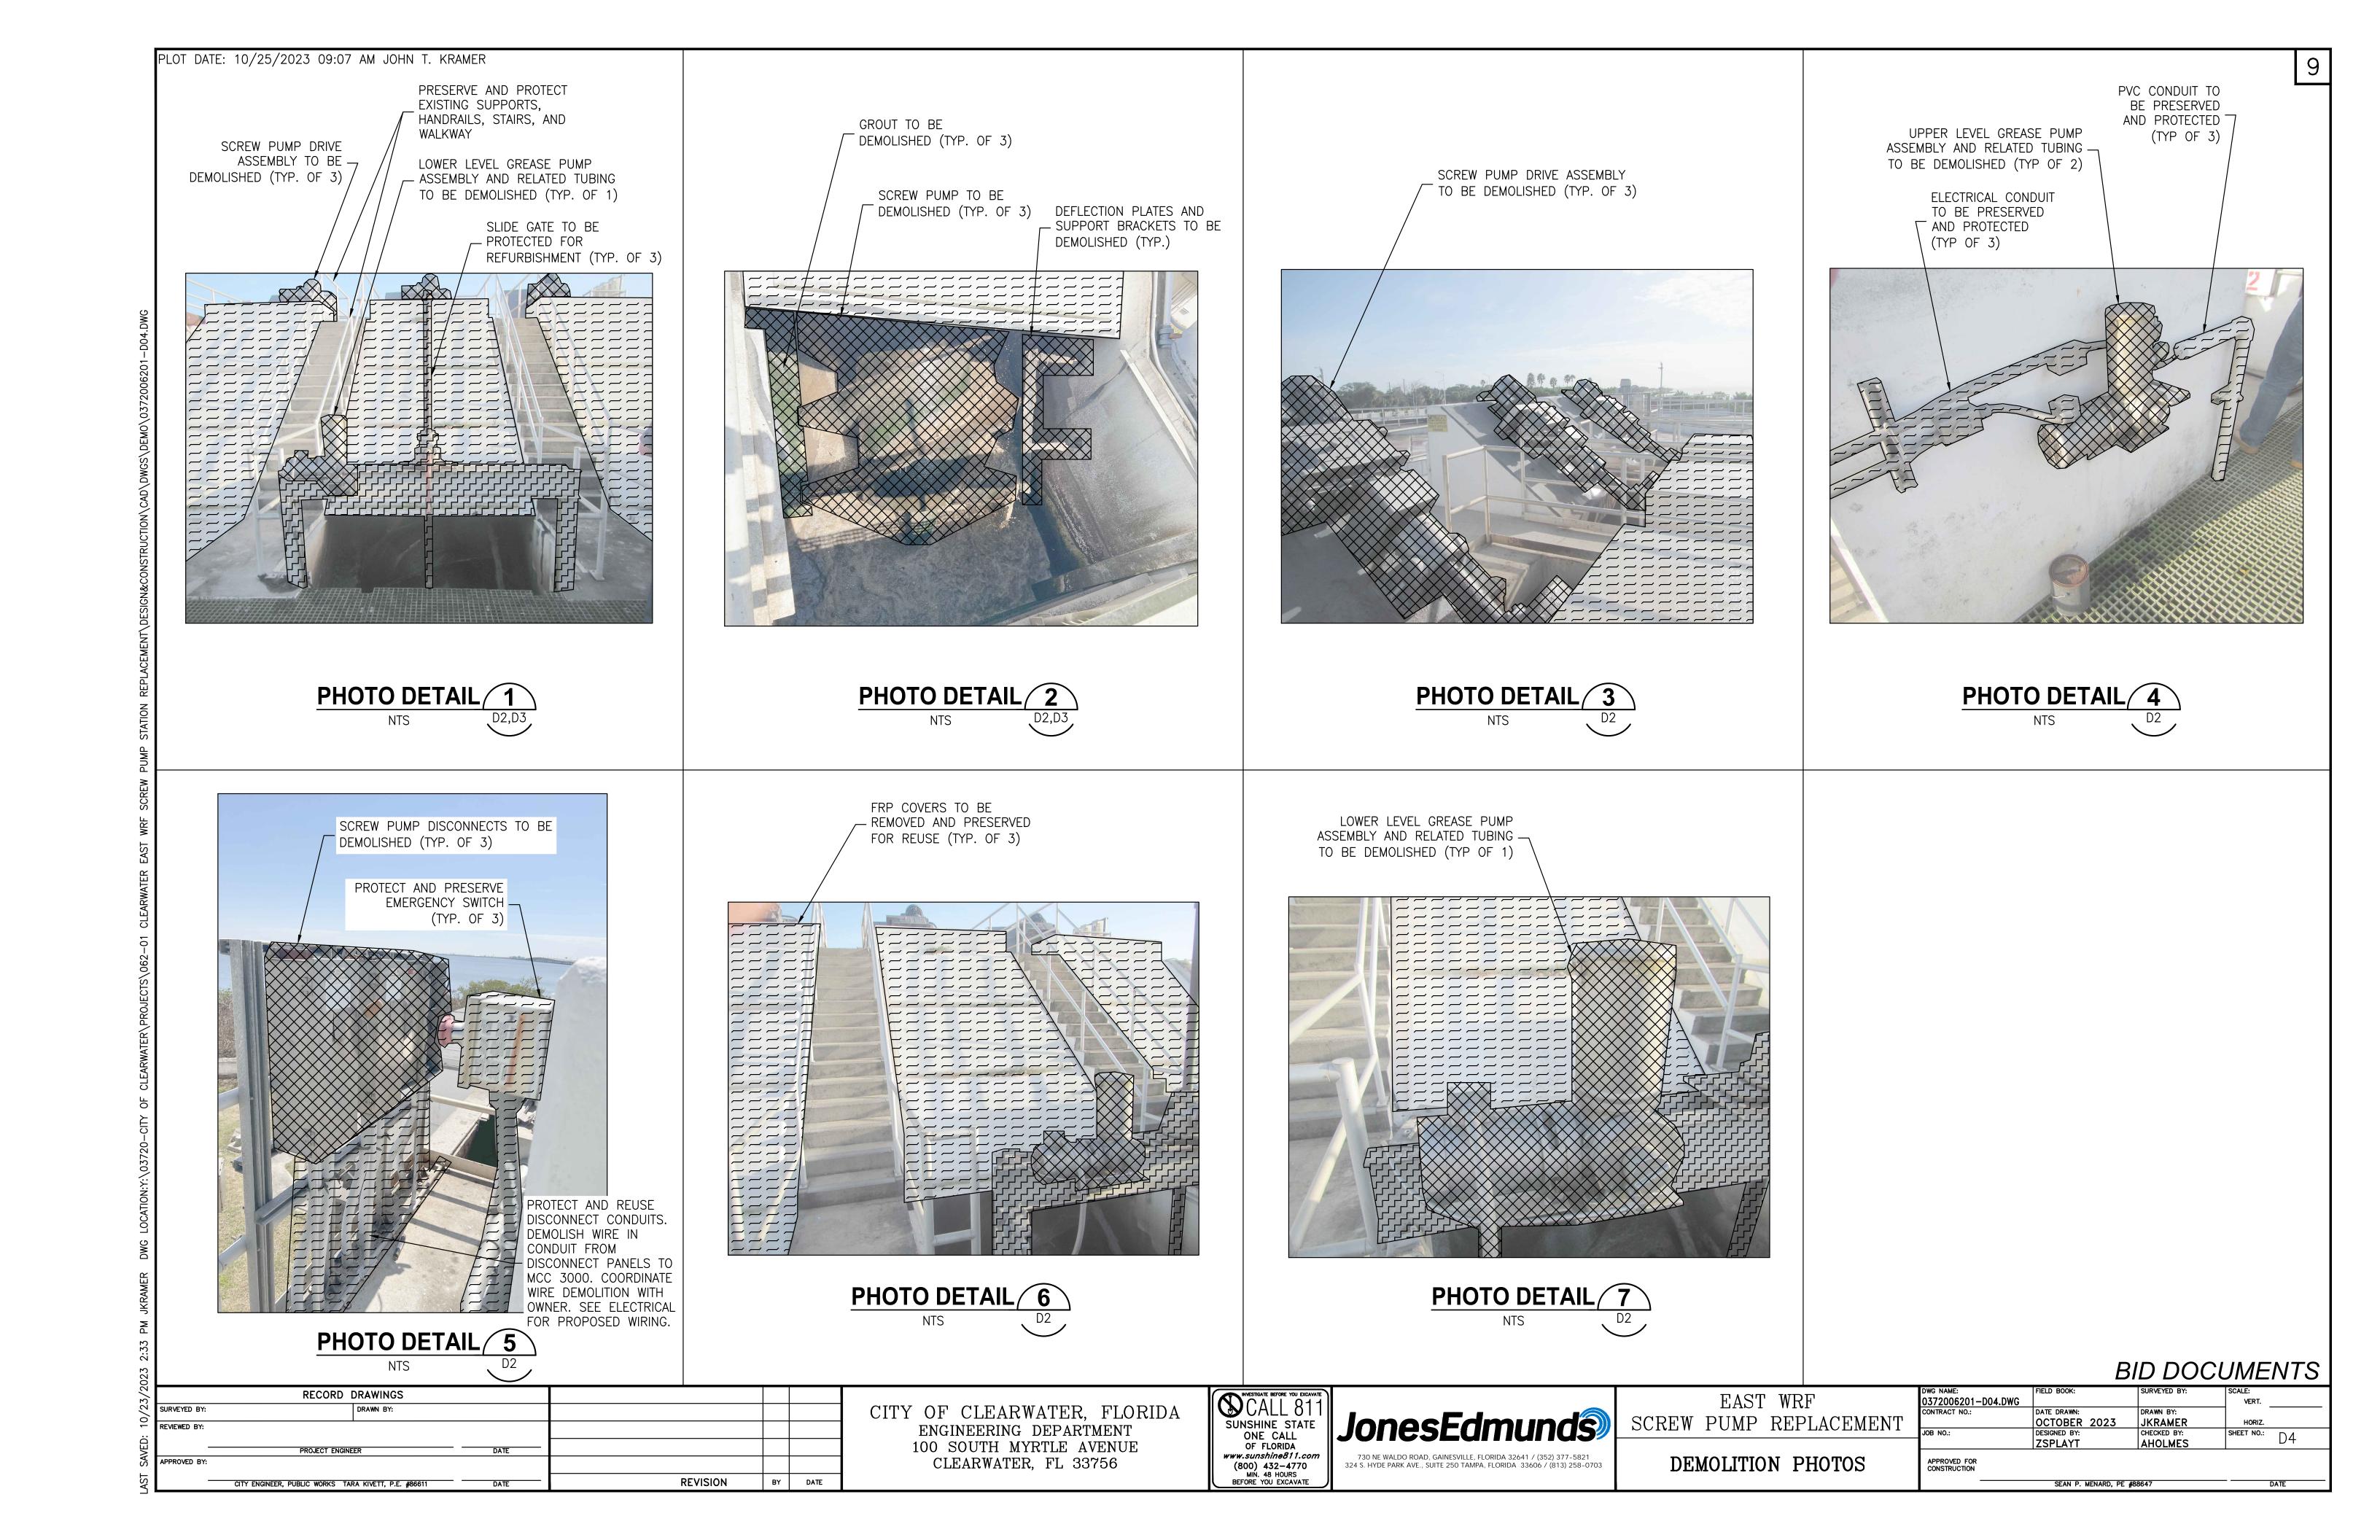

GENERAL CONDITIONS

- 1. ALL STRUCTURAL DRAWINGS SHALL BE USED IN CONJUNCTION WITH THE MECHANICAL, CIVIL, ELECTRICAL, AND SHOP DRAWINGS AND SPECIFICATIONS.
- 2. THE CONTRACTOR SHALL REVIEW AND VERIFY DIMENSIONS SHOWN IN ALL PLANS AND REVIEW ALL FIELD CONDITIONS THAT MAY AFFECT THE WORK DEPICTED ON THE DRAWINGS. SHOULD DISCREPANCIES APPEAR, THE CONTRACTOR SHALL NOTIFY THE ENGINEER IN WRITING TO OBTAIN ENGINEER'S CLARIFICATION BEFORE COMMENCING WITH THE WORK.
- 3. FOR ALL ITEMS EMBEDDED IN OR PASSING THROUGH CONCRETE, THE CONTRACTOR SHALL INITIALLY REFER TO MECHANICAL DRAWINGS FOR TYPE, SIZE, LOCATION, AND SPECIAL INSTALLATION REQUIREMENTS FOR THESE ITEMS.
- 4. THE CONTRACTOR SHALL TAKE ALL NECESSARY MEASURES TO PROTECT EXISTING STRUCTURES FROM DAMAGE WHEN WORKING IN AND AROUND EXISTING STRUCTURES PERFORMING WORK SUCH AS DEMOLITION, FOUNDATION EXCAVATIONS, AND OTHERS.
- 5. SIZE AND LOCATION OF EQUIPMENT PADS AND ANCHOR BOLTS SHALL BE PER EQUIPMENT MANUFACTURER'S REQUIREMENTS.
- 6. ANY EQUIPMENT THAT MAY INDUCE VIBRATION TO THE STRUCTURE SHALL BE ADEQUATELY ISOLATED FROM THE STRUCTURE.
- ALL DETAILS AND SECTIONS SHOWN ON THE DRAWINGS ARE INTENDED TO BE TYPICAL AND SHALL BE CONSTRUED TO APPLY TO ANY SIMILAR SITUATION ELSEWHERE ON THE PROJECT. EXCEPT WHERE A DIFFERENT DETAIL IS SHOWN.

DESIGN CRITERIA

BUILDING CODES AND REFERENCES

- 1. 2020 FLORIDA BUILDING CODE (FBC), SEVENTH EDITION
- 2. REINFORCED CONCRETE:

WATER RETAINING ENVIRONMENTAL STRUCTURES: ACI 350-20 "CODE REQUIREMENTS FOR ENVIRONMENTAL ENGINEERING CONCRETE STRUCTURES"

ALL OTHER STRUCTURES: ACI 318-14 "BUILDING CODE REQUIREMENTS FOR STRUCTURAL CONCRETE"

- 3. STRUCTURAL STEEL: AISC MANUAL OF STEEL CONSTRUCTION, 14TH EDITION
- 4. ALUMINUM: ADM1-2015, ALUMINUM DESIGN MANUAL


WATERTIGHTNESS OF REINFORCED CONCRETE WATER RETAINING STRUCTURES

HYDROSTATICALLY TEST REINFORCED CONCRETE STRUCTURES WHICH WILL CONTAIN WATER PER SPECIFICATIONS AND IN ACCORDANCE TO ACI 350.1-TIGHTNESS TESTING OF ENVIRONMENTAL ENGINEERING STRUCTURES. ALL REPAIRS AND RETESTING OF TANKS SHALL BE ACCOMPLISHED AT NO ADDITIONAL COST TO THE OWNER.


×	AND	EMBED	EMBEDMENT	OD	OUTSIDE DIAMETER
<u>D</u>	AT	EQ	EQUAL	OH	OPPOSITE HAND
ŧ	NUMBER	EW	EACH WAY	OPNG	OPENING
ADDTL	ADDITIONAL	EXIST	EXISTING	PCS	PIECES
١FF	ABOVE FINISHED	EXP	EXPANSION	PEMB	PRE-ENGINEERED
	FLOOR	FE	FIRE EXTINGUISHER		METAL BUILDING
ALUM	ALUMINUM	FF	FAR FACE, FINISHED	PERP	PERPENDICULAR
AEWS	AUTOMATIC END		FLOOR	PL	PLATE
	WELDED STUD(S)	FG	FINISHED GRADE	PLF	POUND PER LINEAR
\LT	ALTERNATE	FRP	FIBER REINFORCED		FOOT
APROX	APPROXIMATE(LY)		PLASTIC	PT	PRESSURE TREATED
BLD	BUILDING	FT	FOOT	PROJ	PROJECTION
3M	BEAM	FTG	FOOTING	PSF	POUNDS PER SQUARE
BOT	BOTTOM	FV	FIELD VERIFY		FOOT
CJ	CONTROL JOINT	GA	GAGE	PSI	POUNDS PER SQUARE
CL	CENTER LINE	GALV	GALVANIZED		INCH
CLR	CLEAR	HK	HOOK	PVC	POLYVINYL CHLORIDE
CMU	CONCRETE MASONRY	HORIZ	HORIZONTAL	R	RADIUS
	UNIT	HSS	HOLLOW STRUCTURAL	REINF	REINFORCING
COL	COLUMN		SECTION	REQD	REQUIRED
CONC	CONCRETE	HP	HIGH POINT	RO	ROUGH OPENING
CONN	CONNECTION	ID	INSIDE DIAMETER	SCHED	SCHEDULE(D)
CONST JT	CONSTRUCTION JOINT	JT	JOINT	SIM	SIMILAR
CONT	CONTINUOUS	LB(S)	POUND(S)	SJ	SAWCUT JOINT
CTR	CENTER	LONG	LONGITUDINAL	SMS	SHEET METAL SCREW
NΑ	DIAMETER	LP	LOW POINT	SPECS	SPECIFICATIONS
MIC	DIMENSION	MANUF	MANUFACTURER	SQ	SQUARE
DEG	DEGREE(S)	MATL	MATERIAL	SS	STAINLESS STEEL
00	DITTO	MAX	MAXIMUM	STD	STANDARD
OWG	DRAWING	MECH	MECHANICAL	STL	STEEL
OWL	DOWEL(S)	MFR	MANUFACTURER	T/	TOP OF
E)	EXISTING	MIN	MINIMUM	TB	TIE BEAM
E) EA	EACH	MISC	MISCELLANEOUS	T&B	TOP AND BOTTOM
F	EACH FACE	MO	MASONRY OPENING	THK	THICK
J	EXPANSION JOINT	MTL	METAL	THRU	THROUGH
EL	ELEVATION	NO	NUMBER	TOC	TOP OF CONCRETE
ELEC	ELECTRICAL	NTS	NOT TO SCALE	TOS	TOP OF STEEL
		OC	ON CENTER	TYP	TYPICAL
				UNO	UNLESS NOTED
					OTHERWISE
				VERT	VERTICAL
				WT	WEIGHT
				WWF	WELDED WIRE FABRIC

LEGEND


STRUCTURAL LEGEND APPLIES TO "S" SHEETS ONLY

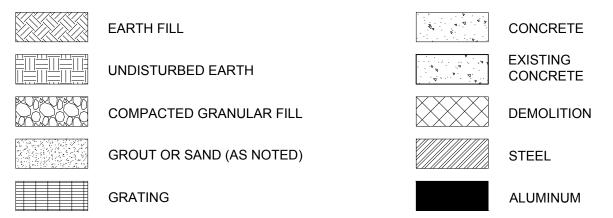

SYMBOLS

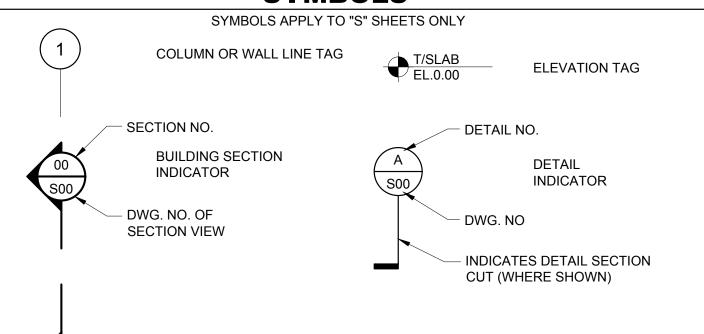

STRUCTURAL ABBREVIATIONS

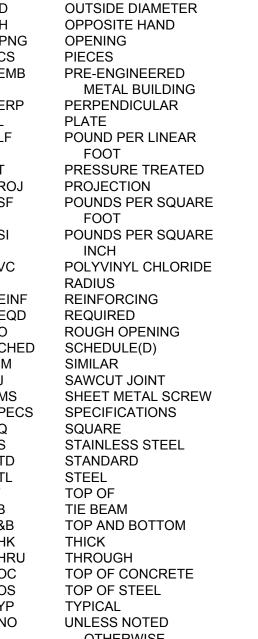

DETAIL N.T.S.

PROPOSED JOINT

PER NOTES

FILLER AS REQUIRED

PROVIDE JOINT FILLER MATERIAL BEHIND JOINT SEALANT TO REPLACE EXISTING JOINT MATERIAL WHICH IS NOT SUITABLE TO REMAIN. COORDINATE DEPTH OF PROPOSED JOINT FILLER TO MAINTAIN A MINIMUM DEPTH OF SEALANT AS SHOWN ON DETAILS OR AS REQUIRED BY THE SEALANT MANUFACTURER. JOINT FILLER MATERIAL SHALL BE PRE-MOLDED SELF-EXPANDING CORK CONFORMING TO ASTM D1752, TYPE II OR III OR EQUAL. SEALANT SHALL BE BASF MASTERSEAL NP 2 WITH PRIMER OR EQUAL. PREPARE ALL SURFACES IN ACCORDANCE WITH MANUFACTURER'S INSTRUCTIONS. ALL

EXPANSION JOINT REPAIR - SLAB OR WALL

VERIFY

PRODUCTS SHALL BE INSTALLED IN STRICT CONFORMANCE WITH THE MANUFACTURER'S INSTRUCTIONS.

3. PAINT ALL AFFECTED SURFACES TO MATCH EXISTING.

FACE OF SAWCUT CONC SURFACE OR EXISTING SURFACE EXPOSED REINFORCEMENT OR ANCHOR ROD TO BE GRINDED BACK TO A DEPTH OF 1/2" BELOW EXISTING CONCRETE SURFACE. APPLY HEAVY COAT OF SIKA ARMATEC 110 BONDING AGENT AND PATCH W/ SIKATOP 123


PLUS REPAIR MORTAR.


NTS

1. DETAIL IS APPLICABLE TO VERTICAL AND HORIZONTAL SURFACES.

2. REINFORCEMENT/STEEL SHALL BE FREE OF RUST AT TIME OF COATING. APPLY PROTECTIVE COATING ACCORDING TO MANUFACTURER'S WRITTEN INSTRUCTIONS AND RECOMMENDATIONS.

CONCRETE REPAIR AT ANCHORS OR REINF

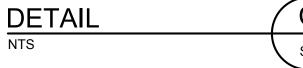

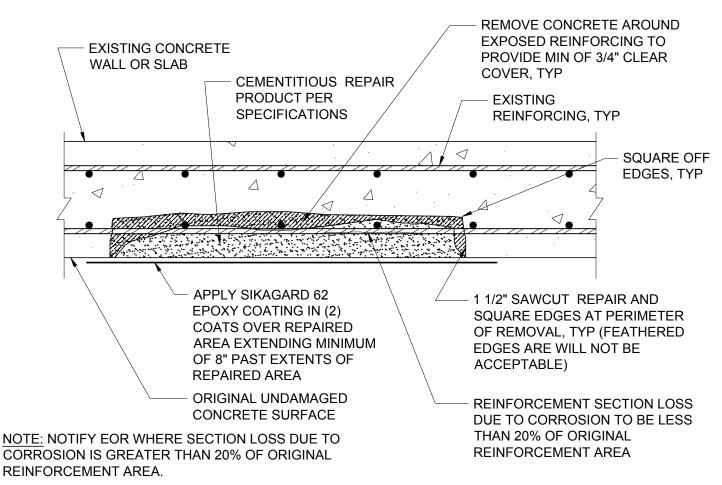

- SAWCUT DEPTHS SHALL BE LIMITED TO PREVENT DAMAGE TO EXISTING REINFORCING STEEL 2. REPAIR DEPTH IS DEFINED AS DEPTH OF REMOVAL OF UNSOUND CONCRETE AFTER SURFACE
- BLASTING HAS BEEN PERFORMED.

PROPOSED JOINT SEALANT W/

CONTINUOUS STRIP OF BOND


BREAKER TAPE AT BOTTOM

EXISTING JOINT

MATERIAL

- 3. ALL AREAS OF UNSOUND CONCRETE SHALL BE MARKED BY THE CONTRACTOR ONCE EXISTING SURFACES HAVE BEEN CLEANED FOR THE OWNER/ENGINEER'S REVIEW PRIOR TO PROCEEDING WITH REPAIRS.
- 4. CONCRETE SURFACE PREPARATION SHALL BE A MINIMUM OF SSPC-SPC13/NACE NO.6 COMMERCIAL BLAST CLEANING AND AS REQUIRED BY COATING SYSTEM MANUFACTURER. A SURFACE PROFILE EQUAL TO ICRI CSP 5 OR GREATER SHALL BE ESTABILISHED.
- 5. ALL EXPOSED REINFORCING STEEL SHALL BE THOROUGHLY CLEANED FREE OF RUST PRIOR TO PLACEMENT OF CEMENTITIOUS REPAIR MATERIAL OR BONDING AGENT. THE REINFORCING STEEL SHALL BE ABRASIVE BLASTED TO WHITE METAL CONDITION IN CONFORMANCE WITH SSPC-SP5/NACE NO.1.
- 6. ANY ACTIVE INFILTRATION SHALL BE INJECTED PRIOR TO APPLICATION OF COATINGS.

CONCRETE REPAIRS AT WALL AND SLAB SURFACES

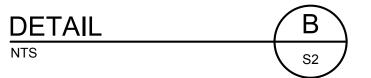



BID DOCUMENTS

RECORD DRAWINGS SURVEYED BY: REVIEWED BY: PPROVED BY: REVISION DATE CITY ENGINEER, PUBLIC WORKS TARA KIVETT, P.E. #86611

CITY OF CLEARWATER, FLORIDA ENGINEERING DEPARTMENT 100 SOUTH MYRTLE AVENUE CLEARWATER, FL 33756


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EAST WRF SCREW PUMP REPLACEMENT

STRUCTURAL NOTES, LEGEND, **SYMBOLS AND ABBREVIATIONS**

DWG NAME:	FIELD BOOK:	SURVEYED BY:	SCALE:
S1.DWG			VERT.
CONTRACT NO.:	DATE DRAWN:	DRAWN BY:	
	OCTOBER 2023	J. MORRIS	HORIZ.
JOB NO.:	DESIGNED BY:	CHECKED BY:	SHEET NO.: C1
	J. SOBCZAK	D. MORRIS	51
APPROVED FOR CONSTRUCTION			
	JOHN V. SOBCZAK, PE	#71407	DATE




— PROVIDE CRACK INJECTION PER REPAIR NOTES ON S2, TYP

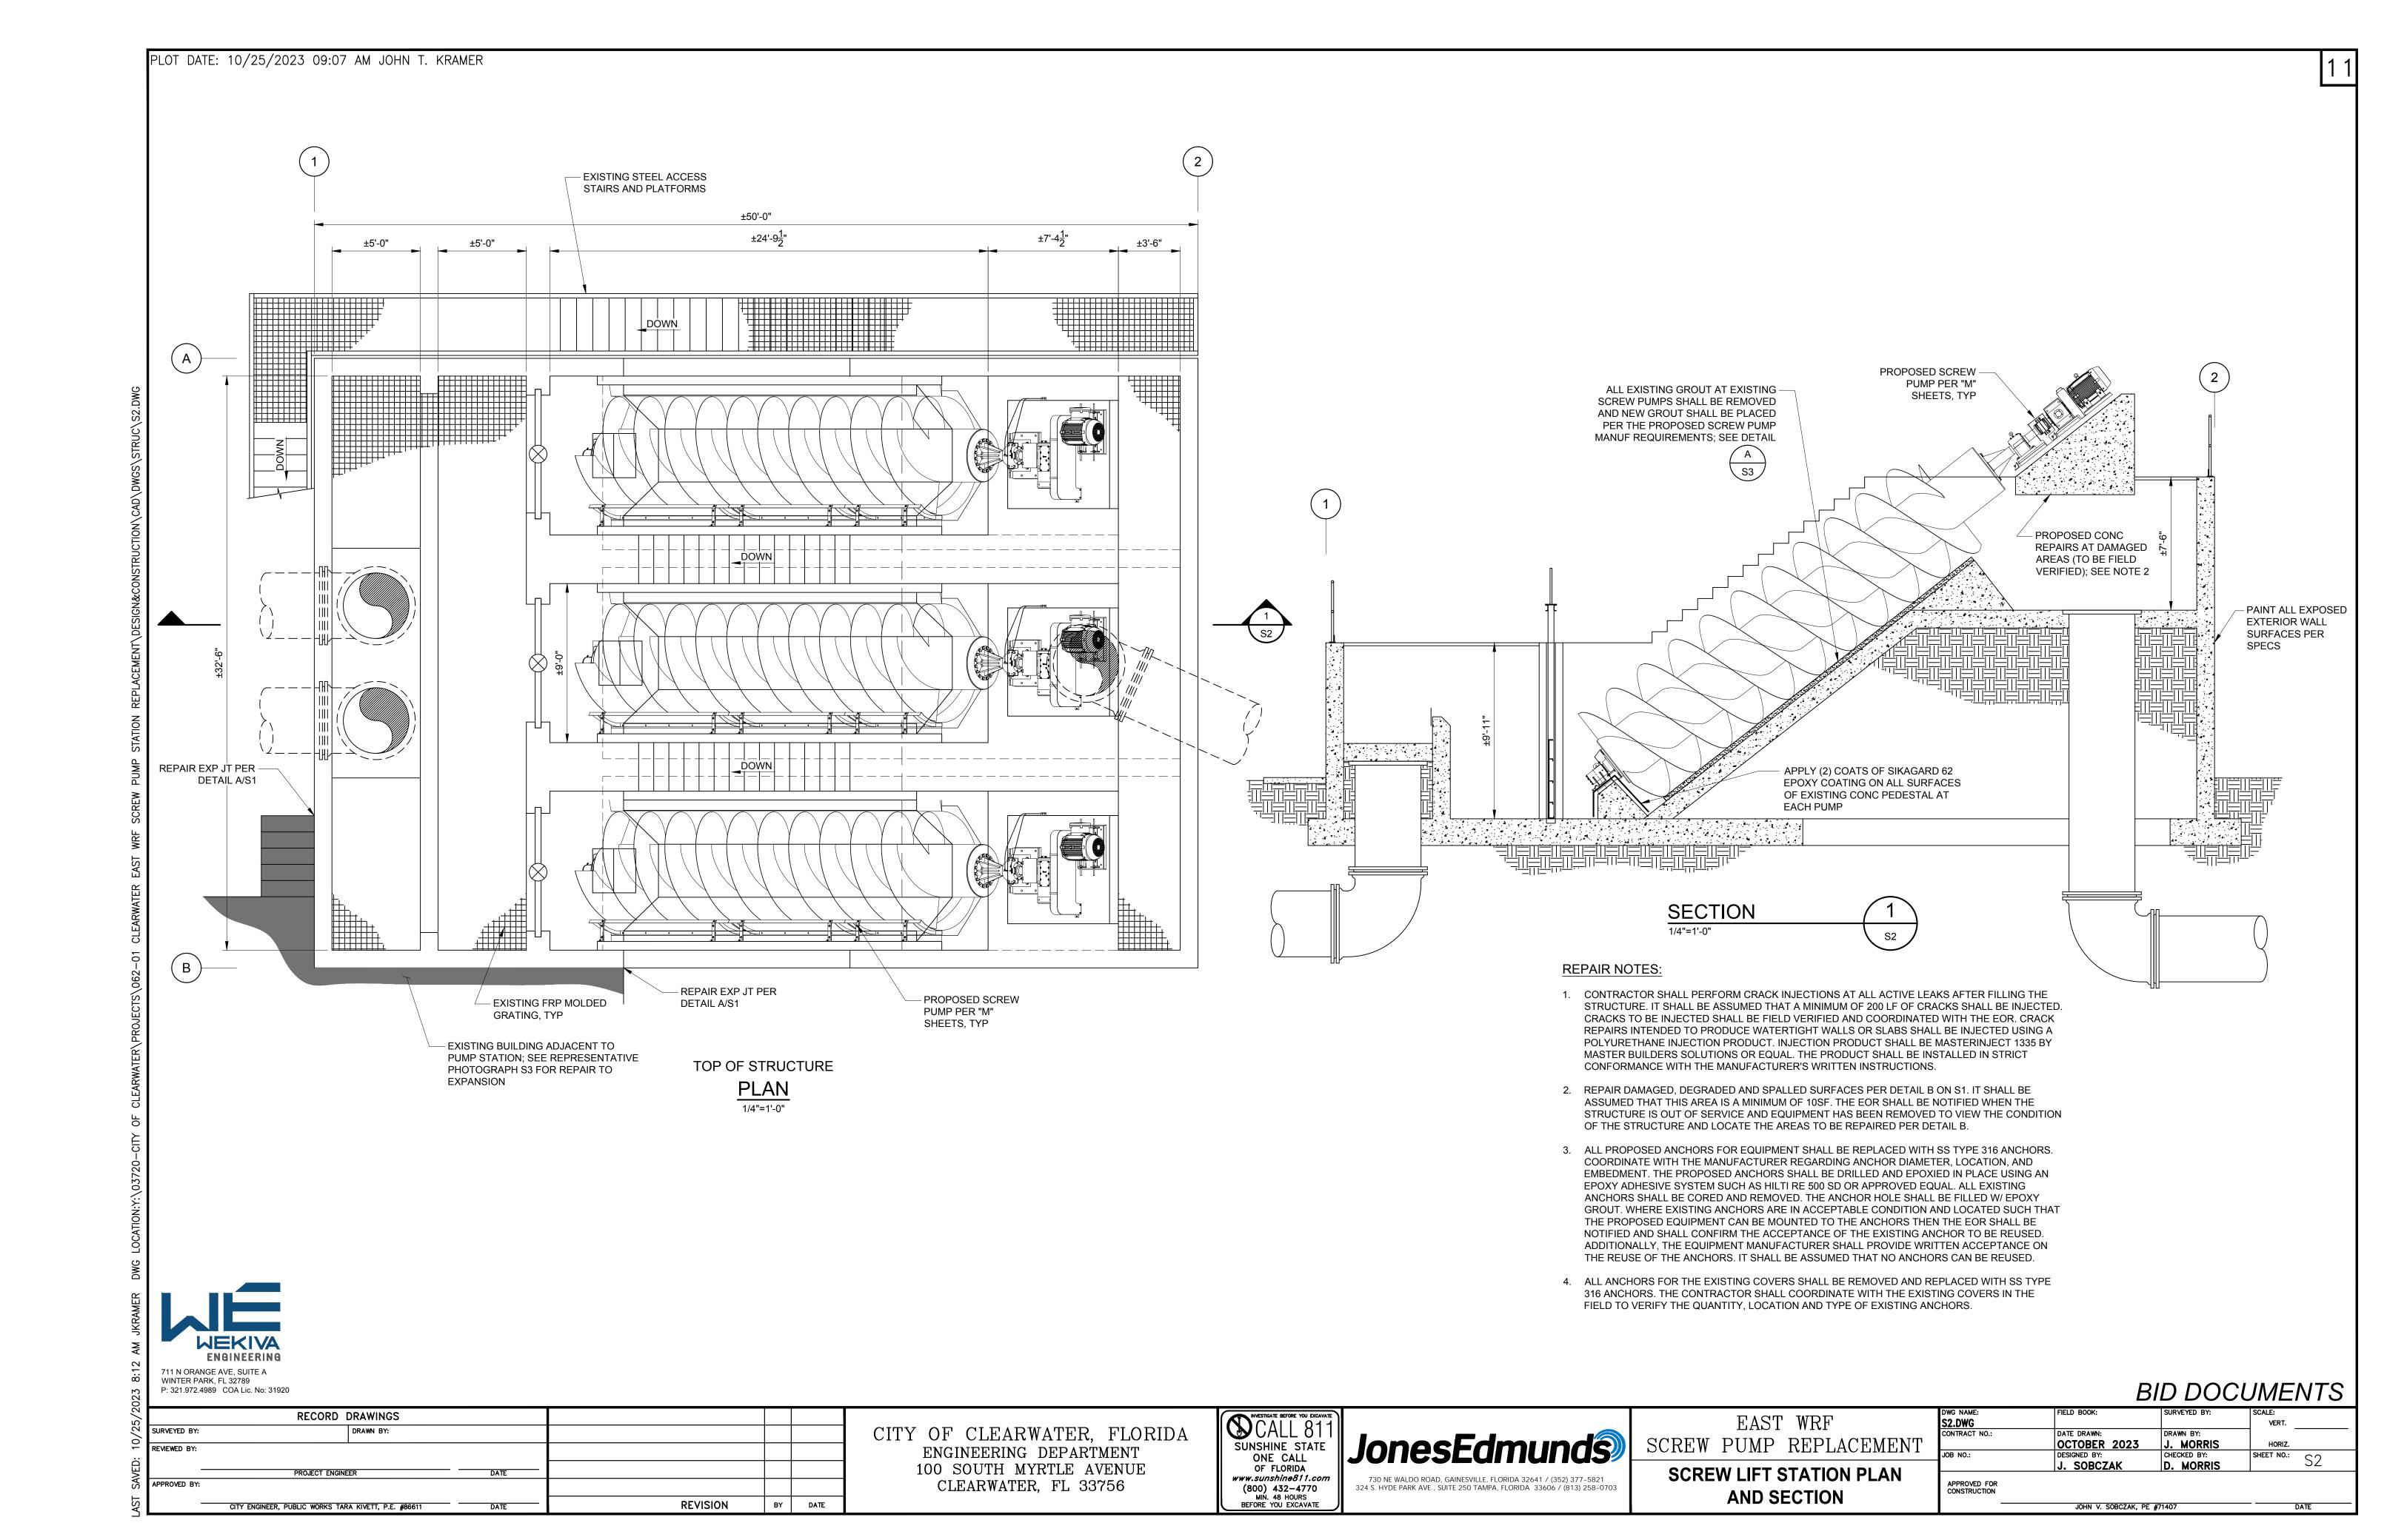


PROVIDE CRACK INJECTION PER REPAIR NOTES ON S2, TYP

ENGINEERING

711 N ORANGE AVE, SUITE A WINTER PARK, FL 32789 P: 321.972.4989 COA Lic. No: 31920 PHOTOGRAPH #1

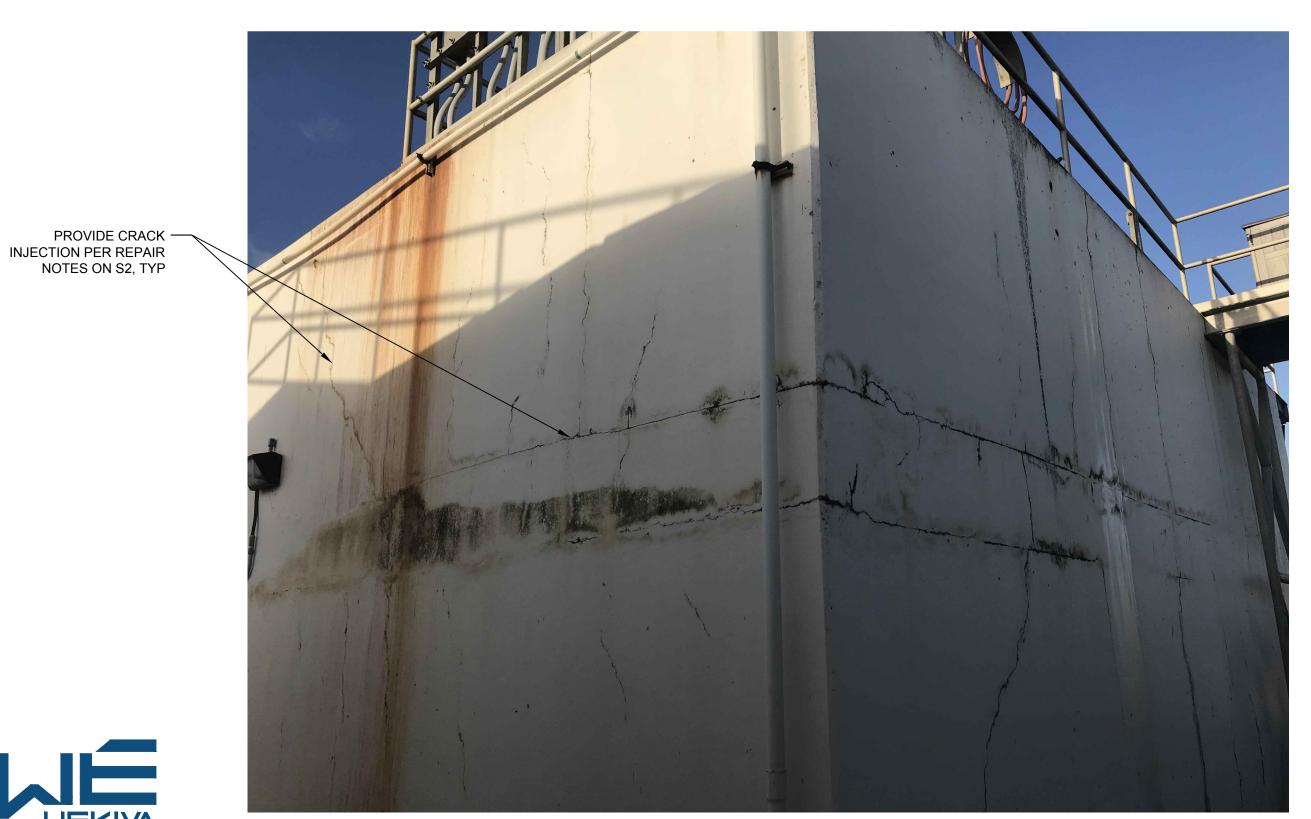

PHOTOGRAPH #3

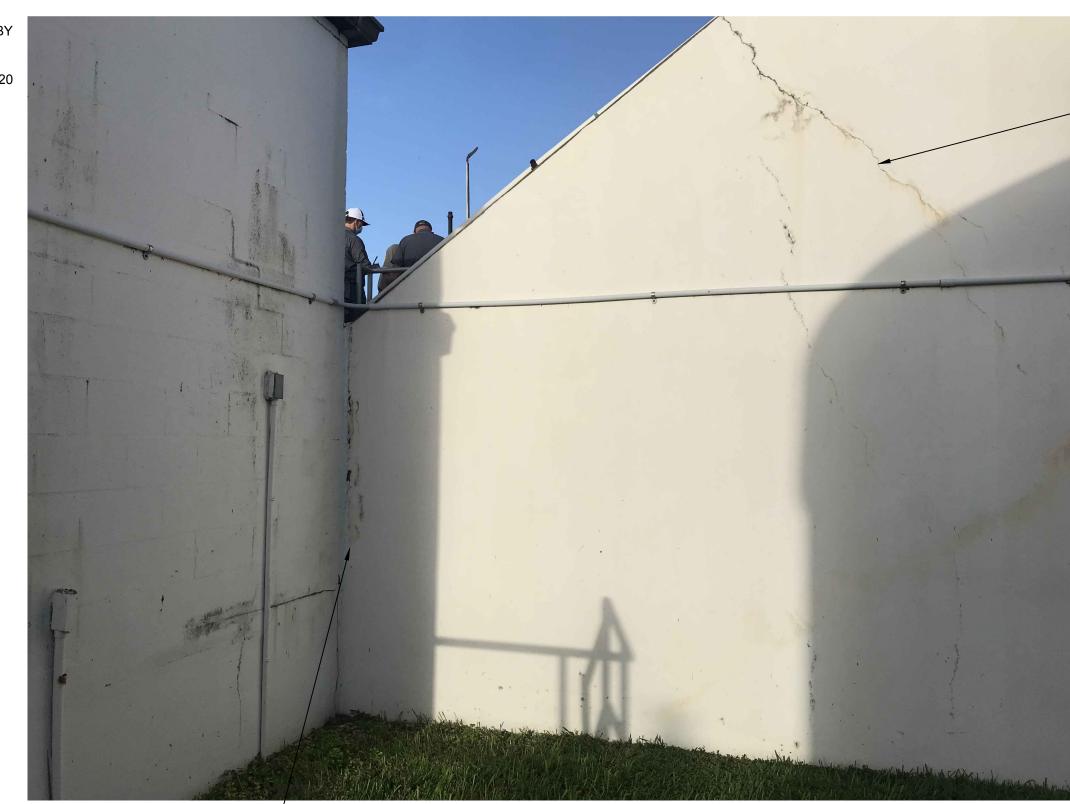

REPAIR EXPANSION JOINT — PER DETAIL A ON S1

PHOTOGRAPH #2

PROPOSED CONC GROUT
PER SPEC SECTION 03800;
COORD GROUT MIX DESIGN
AND GEOMETRY W. SCREW
PUMP MANUF
REQUIREMENTS

REQUIREMENTS

EXISTING CONC
WALL SURFACE

REMOVE EXISTING
CONCRETE AS NEEDED TO
PROVIDE PROFOILE
REQUIRED BY SCREW
PUMP MANUF
REQUIRED BY SCREW
PUMP MANUF
REPOWDE PROFOILE
REQUIRED BY SCREW
PUMP MANUF
REPOWDE PROFOILE
REPOWDE PROFOI

REPAIR NOTES:

1. THE EXISTING GROUT IS NOT SHOWN IN ITS EXISTING CONDITION ENTIRELY IN THIS DETAIL. IT SHALL BE ASSUMED THAT THE EXISTING GROUT IS TO BE REMOVED A MINIMUM OF 3" DEEP ON ALL SIDES OF THE PROPOSED SCREW PUMP TO ALLOW FOR INSTALLATION OF THE PROPOSED EQUIPMENT.

GROUT REPAIRS AT SCREW PUMPS

DETAIL A S2

BID DOCUMENTS

	RECORD D	RAWINGS				
SURVEYED BY:	1	DRAWN BY:				
REVIEWED BY:						
	PROJECT ENGINEER	R	DATE			
APPROVED BY:						
	CITY ENGINEER, PUBLIC WORKS TARA	KIVETT. P.E. #86611	DATE	REVISION	BY	DATE

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	EAST	' WRF
SCREW	PUMP	REPLACEMENT

SCREW LIFT STATION REPAIR
PHOTOGRAPHS

			CIVILIVIO
DWG NAME:	FIELD BOOK:	SURVEYED BY:	SCALE:
S2.DWG			VERT.
CONTRACT NO.:	DATE DRAWN:	DRAWN BY:	
	OCTOBER 2023	J. MORRIS	HORIZ.
JOB NO.:	DESIGNED BY:	CHECKED BY:	SHEET NO.: CZ
	J. SOBCZAK	D. MORRIS	SHEET NO.: S3
APPROVED FOR CONSTRUCTION	JOHN V. SOBCZAK, PE	#714 07	DATE

DOUBLE LINE

SINGLE LINE

PIPE

WELDED PIPE

FLANGED JOINT

EXPANSION JOINT

BALL JOINT

THRUST TIES

BLIND FLANGE

ELBOW UP

TEE UP

TEE DOWN

EXISTING PIPE AND EQUIPMENT IS SHOWN IN THE DRAWINGS AS LIGHT-LINED

DRAWINGS AS HEAVY-LINED. ABOVE GRADE PIPE AND EQUIPMENT ARE SHOWN

AND/OR SCREENED. PROPOSED PIPE AND EQUIPMENT ARE SHOWN IN THE

IN DRAWINGS AS SOLID-LINED. BELOW GRADE PIPE AND EQUIPMENT ARE

SHOWN IN DRAWINGS AS DASHED-LINED. SEE BELOW EXAMPLES:

 $-| \odot |$

ELBOW DOWN

HUB & SPIGOT JOINT

MECHANICAL JOINT OR

RESTRAINED PUSH-ON JOINT

FLEXIBLE COUPLING ADAPTER

FLANGED COUPLING ADAPTER W/ THRUST TIES

FEMALE QUICK DISCONNECT FITTING

MALE QUICK DISCONNECT FITTING

EXISTING PIPE (ABOVE GRADE)

NEW PIPE (BELOW GRADE)

FLEXIBLE COUPLING WITH

LATERAL UP

UNION

ANCHOR

WYE

TEE

ELBOW, 22.5 DEGREE

LATERAL DOWN

CONCENTRIC REDUCER

ECCENTRIC REDUCER

ELBOW, 90 DEGREE

ELBOW, 45 DEGREE

ABANDON IN PLACE

DEMOLISH AND REMOVE

DOUBLE LINE

SINGLE LINE

+

-SEATED SIDE

PLUG — | ♦ | BUTTERFLY

BALL

— CHECK

NEEDLE

— DIAPHRAGM

PRESSURE RELIEF

AIR RELEASE AND/OR VACUUM RELIEF

REGULATED SIDE

HYDRAULIC CONTROL VALVE

ACTUATOR SYMBOLS

ELECTROHYDRAULIC

ELECTRIC MOTOR

PNEUMATIC

HYDRAULIC SOLENOID

MANUAL

ON LOSS OF PRIMARY POWER (PNEUMATIC, ELECTRICAL OR HYDRAULIC) $\dot{X}X$: FO = FAIL OPEN FC = FAIL CLOSEDFLP = FAIL TO LAST POSITION

EQUIPMENT SYMBOLS

SLIDE GATE


PIPE SUPPORT SYMBOLS

FLANGED PIPE SUPPORT

U-SHAPED PIPE SUPPORT

PIPE SUPPORT W/ AXIAL LOAD SUPPORT

EQUIPMENT DESIGNATION

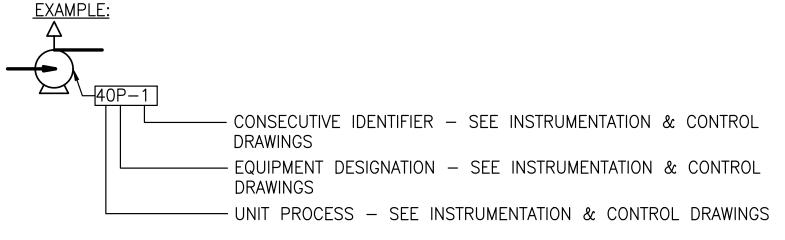

DID DOCLIMENTS

RECORD DRAWINGS SURVEYED BY: REVIEWED BY: PPROVED BY: REVISION DATE CITY ENGINEER, PUBLIC WORKS TARA KIVETT, P.E. #86611


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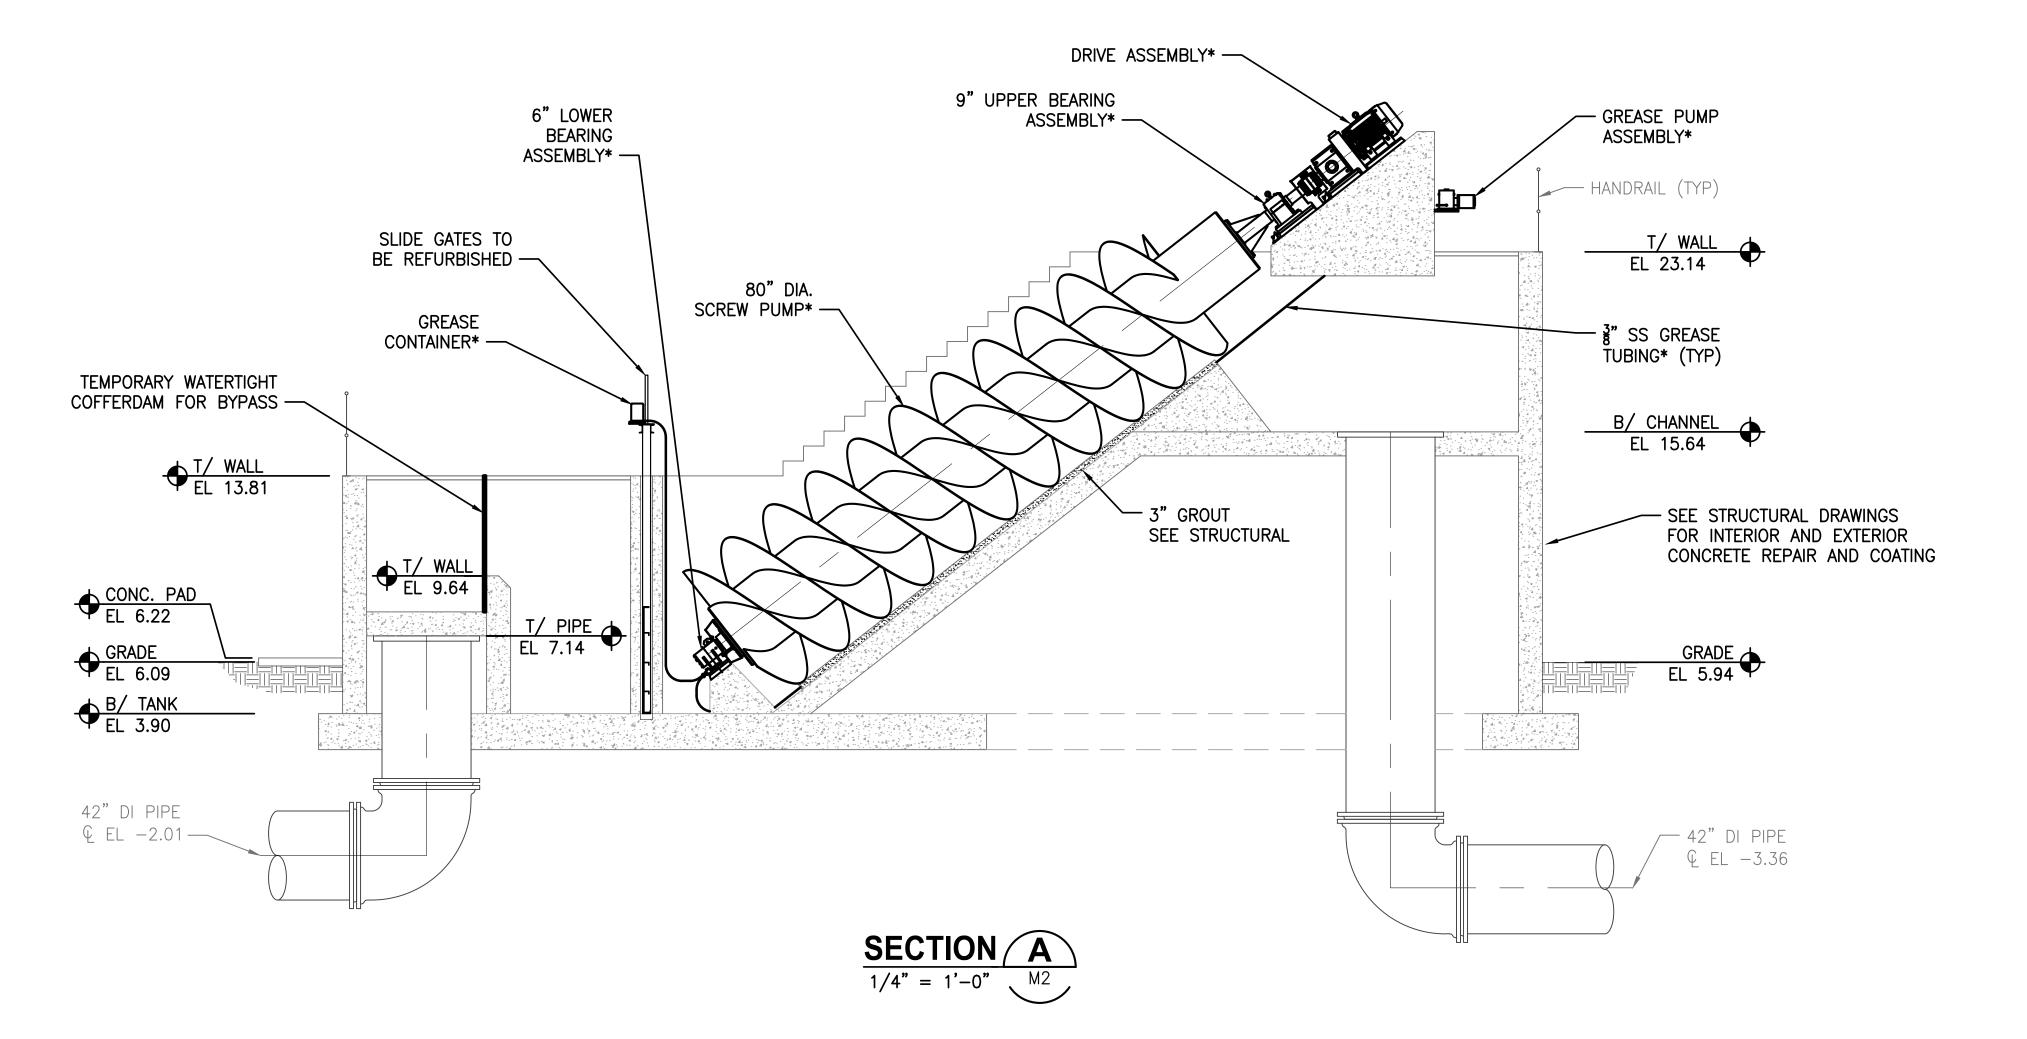
EAST WRF SCREW PUMP REPLACEMENT MECHANICAL NOTES, LEGEND AND ABBREVIATIONS


DWG NAME:	FIELD BOOK:	SURVEYED BY:	SCALE:
0372006201-M01.DWG			VERT.
CONTRACT NO.:	DATE DRAWN:	DRAWN BY:	
	OCTOBER 2023	JKRAMER	HORIZ.
JOB NO.:	DESIGNED BY:	CHECKED BY:	SHEET NO.: M1
	ZSPLAYT	AHOLMES	IVI I
APPROVED FOR			
CONSTRUCTION			



SCALE IN FEET

- 1. EXISTING SCREW PUMP FRP COVERS NOT SHOWN FOR CLARITY. FRP COVERS ARE TO BE REMOVED, PRESERVED, AND REINSTALLED AFTER COMPLETION.
- 2. CONTRACTOR IS RESPONSIBLE FOR ANCHORING NEW EQUIPMENT. SEE STRUCTURAL DRAWINGS FOR ANCHORING.
- 3. NOT ALL STAIRS, HANDRAILS, WALKWAYS, GRATING ARE SHOWN. REFER TO STRUCTURAL DRAWINGS.
- 4. * DENOTES ITEM TO BE FURNISHED BY PUMP MANUFACTURER.
- 5. NOT ALL EQUIPMENT IS SHOWN FOR CLARIFY. THE CONTRACTOR IS RESPONSIBLE TO PRESERVE AND PROTECT EQUIPMENT NOT CALLED OUT IN THE DEMO SHEETS.
- 6. CONTRACTOR SHALL COORDINATE WITH THE SLIDE GATE MANUFACTURER (WATERMAN VALVE LLC) TO INSPECT AND ASSESS THE EXISTING SLIDE GATES AND PROVIDE A DETAILED REPORT FOR REFURBISHMENT OR REPLACEMENT INCLUDING AN ITEMIZED LIST WITH COSTS OF PARTS AND INSTRUCTIONS. CONTRACTOR SHALL SUBMIT THIS REPORT TO THE OWNER AND ENGINEER FOR REVIEW AND APPROVAL. IF THE COST OF REFURBISHMENT OF THE SLIDE GATES IS GREATER THAN DEMOLITION OF EXISTING AND FURNISH AND INSTALLING NEW SLIDE GATES, THEN THE CONTRACTOR SHALL INDICATE THAT IN THE REPORT.

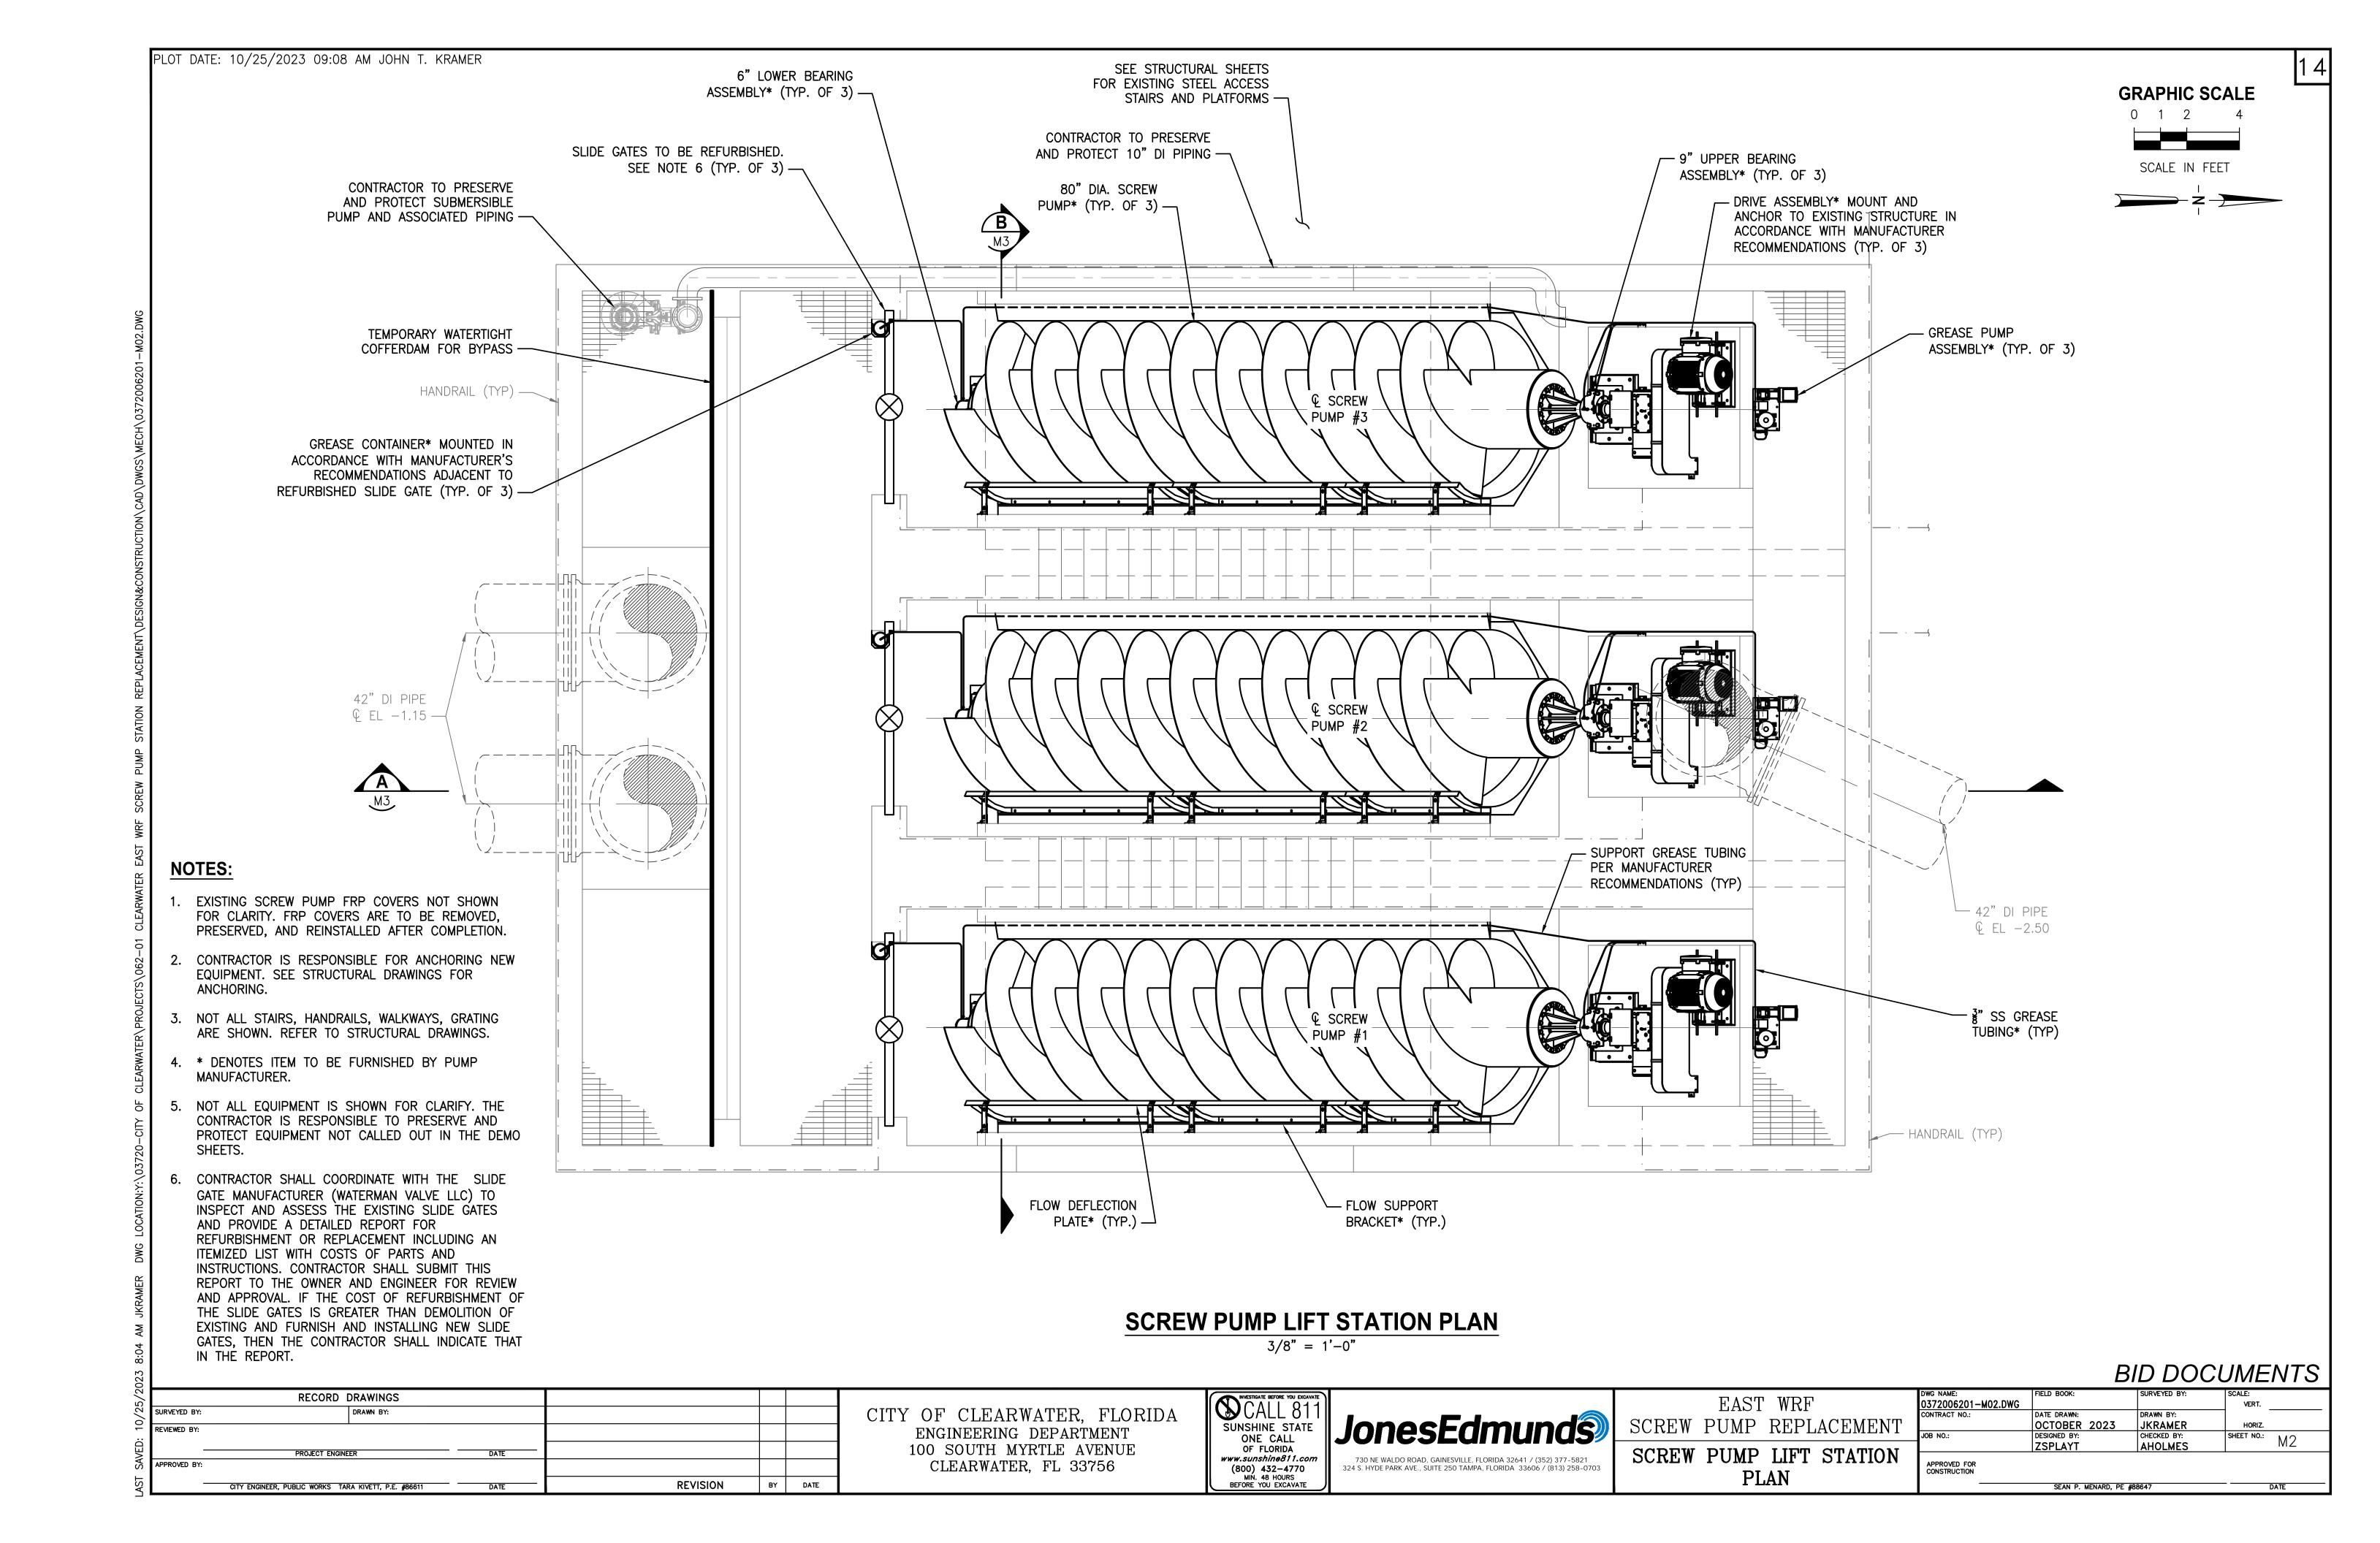

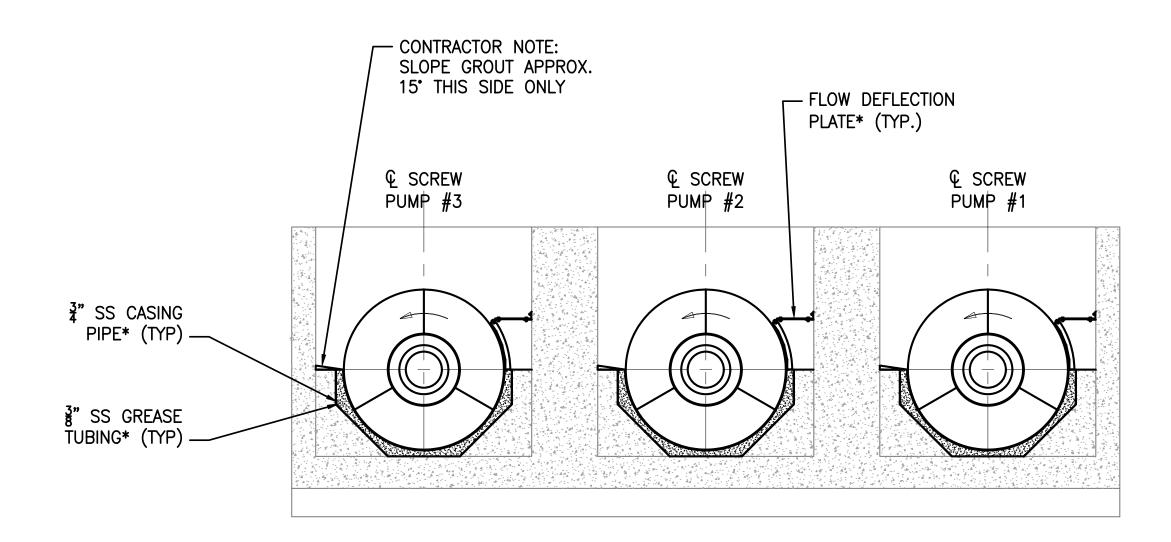

SECTION B1/4" = 1'-0" M2

BID DOCUMENTS

RECORD DRAWINGS

SURVEYED BY:

REVIEWED BY:

PROJECT ENGINEER

DATE

CITY ENGINEER, PUBLIC WORKS TARA KIVETT, P.E. #86611

DATE

REVISION

REVISION

REVISION

BY DATE

CITY OF CLEARWATER, FLORIDA ENGINEERING DEPARTMENT 100 SOUTH MYRTLE AVENUE CLEARWATER, FL 33756





SCREW	11101	WRF REPL	ACEMENT			
SCREW			STATION			
SECTIONS						

DWG NAME:	FIELD BOOK:	SURVEYED BY:	SCALE:
0372006201-M03.DWG			VERT.
CONTRACT NO.:	DATE DRAWN:	DRAWN BY:	1
	OCTOBER 2023	JKRAMER	HORIZ.
JOB NO.:	DESIGNED BY:	CHECKED BY:	SHEET NO.: NAZ
	ZSPLAYT	AHOLMES	SHEET NO.: M3
APPROVED FOR CONSTRUCTION			
	SEAN P. MENARD, PE #8	38647	DATE

SCREW PUMP LIFT STATION POSSIBLE BYPASS PUMPING PLAN

1" = 10'

CITY OF CLEARWATER, FLORIDA SUNSHINE STATE ONE CALL OF FLORIDA ENGINEERING DEPARTMENT 100 SOUTH MYRTLE AVENUE www.sunshine811.com CLEARWATER, FL 33756



EAST WRF SCREW PUMP REPLACEMENT SCREW PUMP LIFT STATION

0372006201-M04.DWG OCTOBER 2023
DESIGNED BY: JKRAMER ZSPLAYT AHOLMES POSSIBLE BYPASS PUMPING PLAN SEAN P. MENARD, PE #8864

BID DOCUMENTS

SHEET NO.: M4

BYPASS NOTES:

1. SEE SPECIFICATION 01815, MAINTENANCE OF PLANT OPERATION AND SEQUENCE OF CONSTRUCTION FOR A SUGGESTED SEQUENCING AND BYPASS PLAN.

GRAPHIC SCALE

SCALE IN FEET

- THIS SHEET REFLECTS A POSSIBLE BYPASS PLAN TO DEMONSTRATE FEASIBILITY. CONTRACTOR IS RESPONSIBLE FOR SUBMITTING THEIR OWN BYPASS PLAN IN ACCORDANCE WITH THE CONTRACT DOCUMENTS AND SPECIFICALLY NOTES 14 THROUGH 17 ON SHEET G2.
- 3. CONTRACTOR SHALL NOTIFY THE OWNER AND ENGINEER 14 CALENDAR DAYS IN ADVANCE FOR A TEMPORARY SHUTDOWN TO INSTALL BYPASS PUMPS, TEMPORARY PIPING, FITTINGS, AND OTHER APPURTENANCES.
- 4. CONTRACTOR SHALL SUBMIT A DETAILED BYPASS PLAN AT LEAST 30 DAYS PRIOR TO BYPASSING FOR OWNER AND ENGINEER REVIEW AND APPROVAL IN ACCORDANCE WITH THE SPECIFICATIONS.
- 5. CONTRACTOR SHALL BE RESPONSIBLE FOR SIZING AND PROVIDING THE NECESSARY NUMBER OF BYPASS PUMPS WITH ONE REDUNDANT PUMP, AND THE TEMPORARY PIPING, VALVES, AND CONTROLS FOR MAINTAINING THE WASTEWATER AND PLANT FLOWS DURING BYPASSING. THIS SHALL BE THE SOLE RESPONSIBILITY OF THE CONTRACTOR. THE CONTRACTOR WILL BE RESPONSIBLE FOR CLEAN UP AND PAY ALL FINES SHOULD ANY OVERFLOWS AND SPILLS OCCUR AT THE SCREW PUMP LIFT STATION OR OTHER HYDRAULICALLY CONNECTED FACILITIES UPSTREAM OR DOWNSTREAM DURING THE BYPASSING REQUIRED FOR THIS PROJECT. FINAL TEMPORARY PIPING SIZING BY CONTRACTOR SHALL BE BASED ON THE PIPE MATERIAL, ROUTE, PUMPING PERFORMANCE AND OTHER FACTORS.
- CONTRACTOR SHALL BE REQUIRED TO COORDINATE WITH THE ENGINEER AND OWNER TO CONFIRM THE FLOW RATE RANGES AS PART OF THE TEMPORARY BYPASS PLAN. THE ESTIMATED FLOW RATE FOR SIZING THE BYPASS PUMPS AND BYPASS SYSTEM FOR THE SCREW PUMP LIFT STATION IS AS FOLLOWS:
- MINIMUM DAY: 10.5 MGD - AVERAGE DAY: 12.0 MGD PEAK HOUR: 17.2 MGD
- 7. CONTRACTOR SHALL PROVIDE PROPER VALVING AND FITTINGS IN THE BYPASS PIPING AND SHALL BE RESPONSIBLE FOR ADEQUATELY SUPPORTING/SECURING TEMPORARY PIPING AND PROTECTING TEMPORARY PUMPS.
- BYPASS PIPING SHALL BE ROUTED TO ALLOW FULL ACCESS TO FACILITIES BY WRF OPERATORS, CHEMICAL DELIVERY DRIVERS, AND ANY APPROVED PERSONNEL WITHOUT OBSTRUCTION TO PLANT ROAD TRAVEL. CONTRACTOR SHALL COORDINATE WITH WRF OPERATORS, OWNER, AND ENGINEER TO ROUTE BYPASS PIPING TO PREVENT TRIPPING HAZARDS AND OTHER SAFETY AND ACCESSIBILITY CONCERNS. CONTRACTOR TO PROVIDE SUFFICIENT SUPPORTS AND FASTENERS TO ROUTE THE BYPASS PIPING.
- BASE BID SHALL ASSUME FULL BYPASS OF ALL THREE SCREW PUMPS. ONE EXISTING SCREW PUMP IS SIZED TO HANDLE THE CURRENT MINIMUM TO PEAK FLOW RANGE. IF CONTRACTOR ELECTS TO PURSUE A MORE ISOLATED BYPASS IN ORDER TO REPLACE ONE SCREW PUMP AT A TIME, A BID ALTERNATE SHALL BE SUBMITTED AND WILL BE SUBJECT TO CONTRACTOR'S SUBMITTED BYPASS PLAN BEFORE APPROVAL BY OWNER AND ENGINEER. A MINIMUM OF TWO SCREW PUMPS ARE REQUIRED TO BE IN OPERATION AT ALL TIMES TO ALLOW CLASS I RELIABILITY.
- 10. CONTRACTOR SHALL MAINTAIN AND OPERATE BYPASS PUMPING SYSTEM.
- 11. BYPASS PUMP SYSTEM SHALL REMAIN IN PLACE DURING START-UP AND TESTING OF THE NEW SCREW PUMPS AND UNTIL THE NEW SCREW PUMPS OPERATION IS SUCCESSFULLY DEMONSTRATED TO THE ENGINEER AND OWNER.

SURVEYED BY: REVIEWED BY: PPROVED BY:


RECORD DRAWINGS


CITY ENGINEER, PUBLIC WORKS TARA KIVETT, P.E. #86611

DATE

REVISION

(800) 432-4770 MIN. 48 HOURS BEFORE YOU EXCAVATE

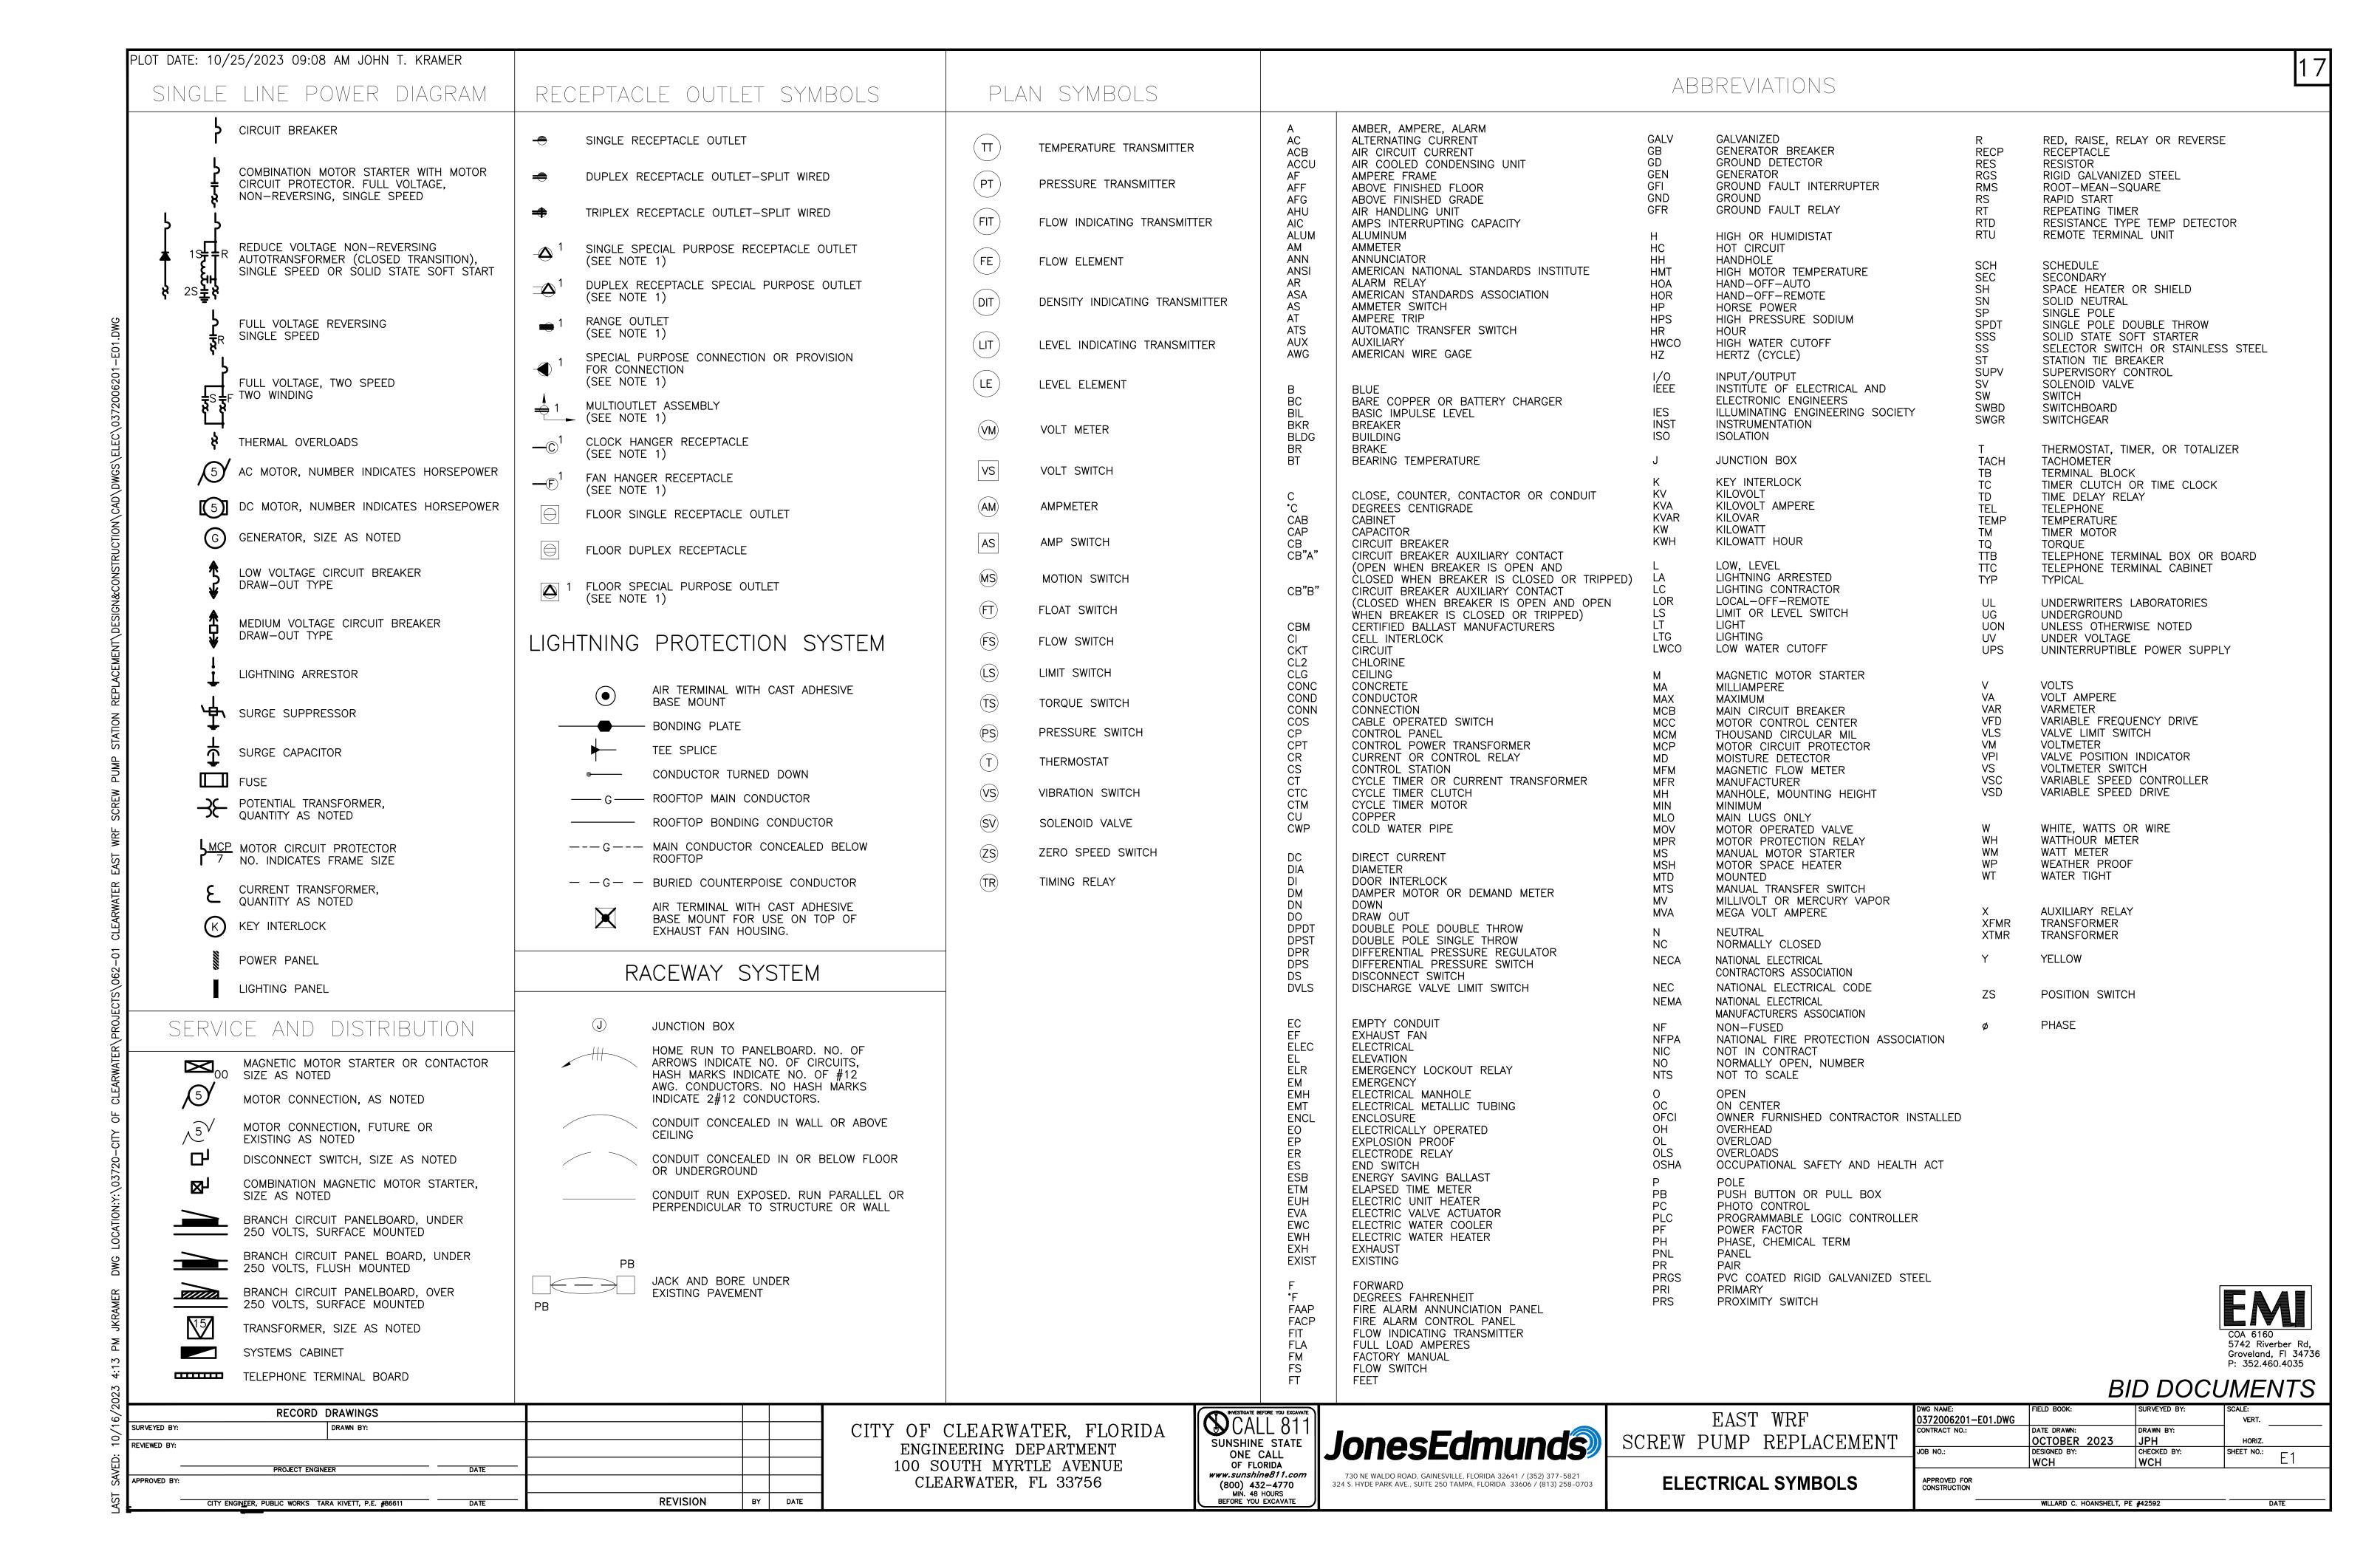

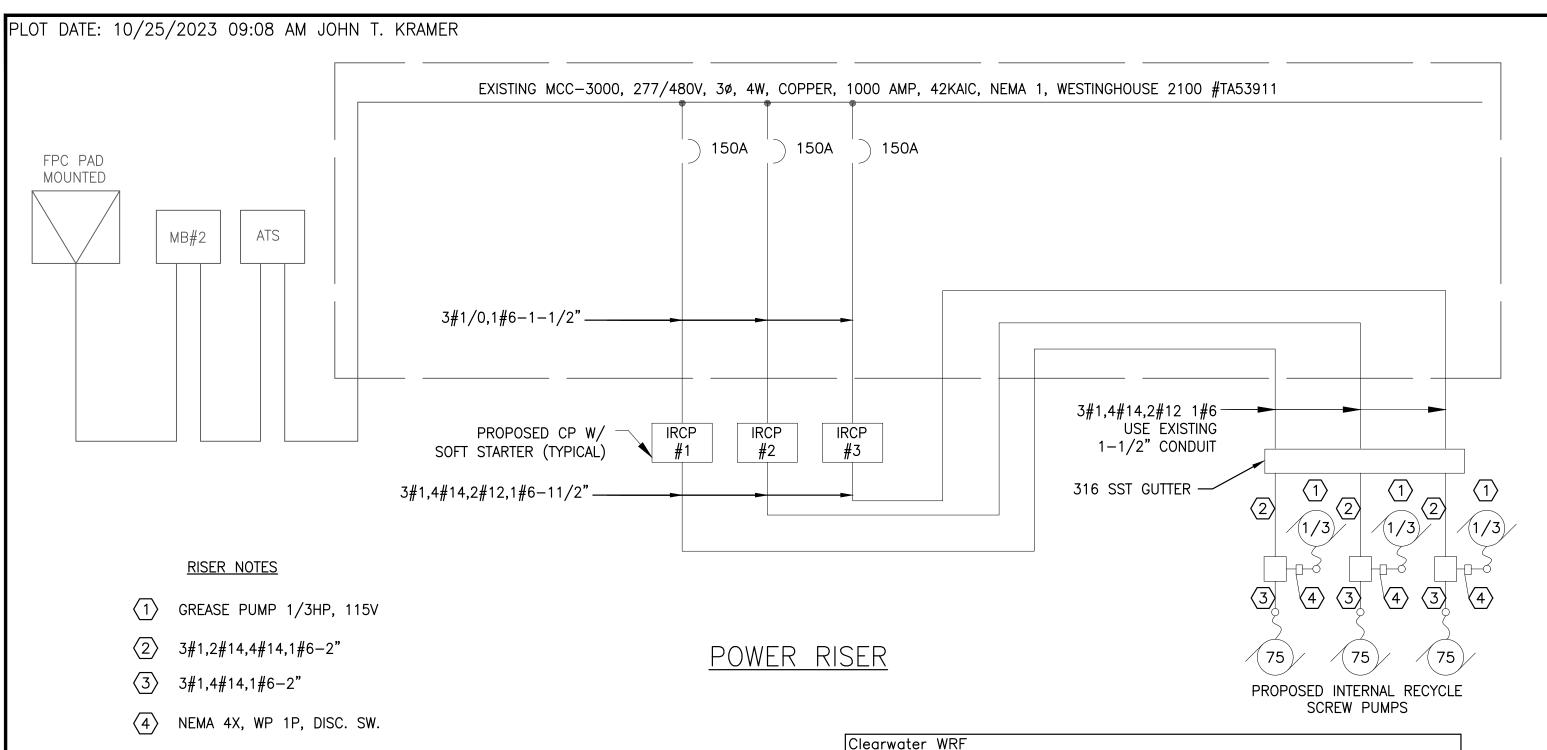


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EXISTING MCC-3000

Clearwater WRF							
Electrical Load MCC—3000 Calculations							
Available Voltage 480v — 3 Phase, 3 Wire,	Available Voltage 480v — 3 Phase, 3 Wire, WYE, Solid Ground						
Maximum Available Fault Current = 20,070A	at Pad Mo	unt					
	Phase A	Phase B	Phase C				
EXISTING LOAD	Amps	Amps	Amps				
AERATOR #1-125HP	156.0	156.0	156.0				
AERATOR #2-125HP	156.0	156.0	156.0				
GENERATOR EXHAUST FAN-5HP	7.6	7.6	7.6				
PANEL L3	80.0	80.0	80.0				
PANEL L5	80.0	80.0	80.0				
PROPOSED LOAD							
SCREW PUMP #1-75HP	96.0	96.0	96.0				
SCREW PUMP #2-75HP	96.0	96.0	96.0				
SCREW PUMP #3-75HP	96.0	96.0	96.0				
25% Largest Motor	39.0	39.0	39.0				
Total	806.6	806.6	806.6				
Existing Service Size = 1000 Amperes							



EXISTING MCC-3000

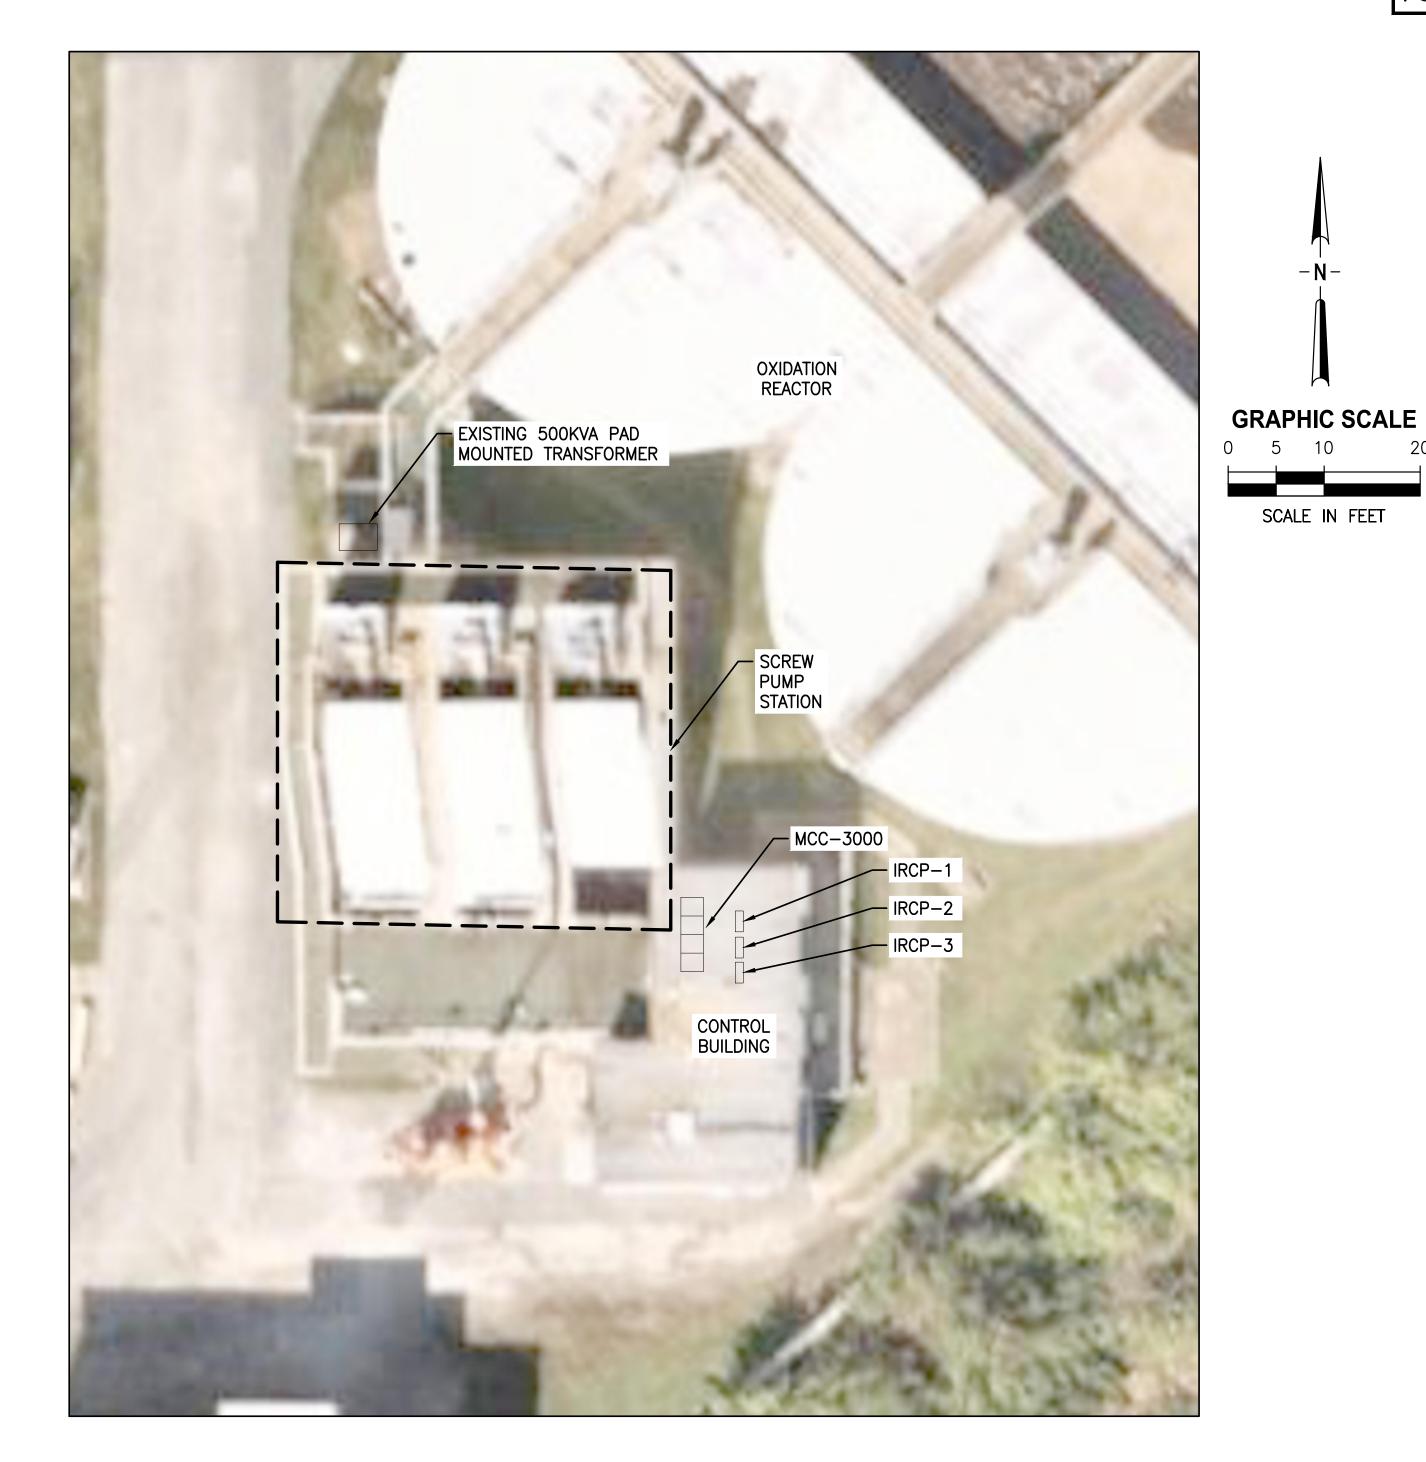


<u>SITE PLAN</u>



BID DOCUMENTS

SURVEYED BY:	RECORD DRAWINGS DRAWN BY:				CITY OF CLEARWATER, FLORIDA	CALL 811		EAST WRF	DWG NAME: 0372006201-E02.DWG CONTRACT NO.:	DATE DRAWN:	SURVEYED BY: DRAWN BY:	SCALE: VERT.
REVIEWED BY:	PROJECT ENGINEER	DATE			ENGINEERING DEPARTMENT 100 SOUTH MYRTLE AVENUE	SUNSHINE STATE ONE CALL OF FLORIDA	Jones Edmunds»	SCREW PUMP REPLACEMENT	JOB NO.:	OCTOBER 2023 DESIGNED BY: WCH	CHECKED BY: WCH	SHEET NO.: E2
APPROVED BY:	CITY ENGINEER, PUBLIC WORKS TARA KIVETT, P.E. #86611	DATE	REVISION	BY DATE	CLEARWATER, FL 33756	www.sunshine811.com (800) 432-4770 MIN. 48 HOURS BEFORE YOU EXCAVATE	730 NE WALDO ROAD, GAINESVILLE, FLORIDA 32641 / (352) 377-5821 324 S. HYDE PARK AVE., SUITE 250 TAMPA, FLORIDA 33606 / (813) 258-0703	ELECTRICAL SITE PLAN AND RISER	APPROVED FOR CONSTRUCTION	WILLARD C. HOANSHELT, F	PE #42592	DATE

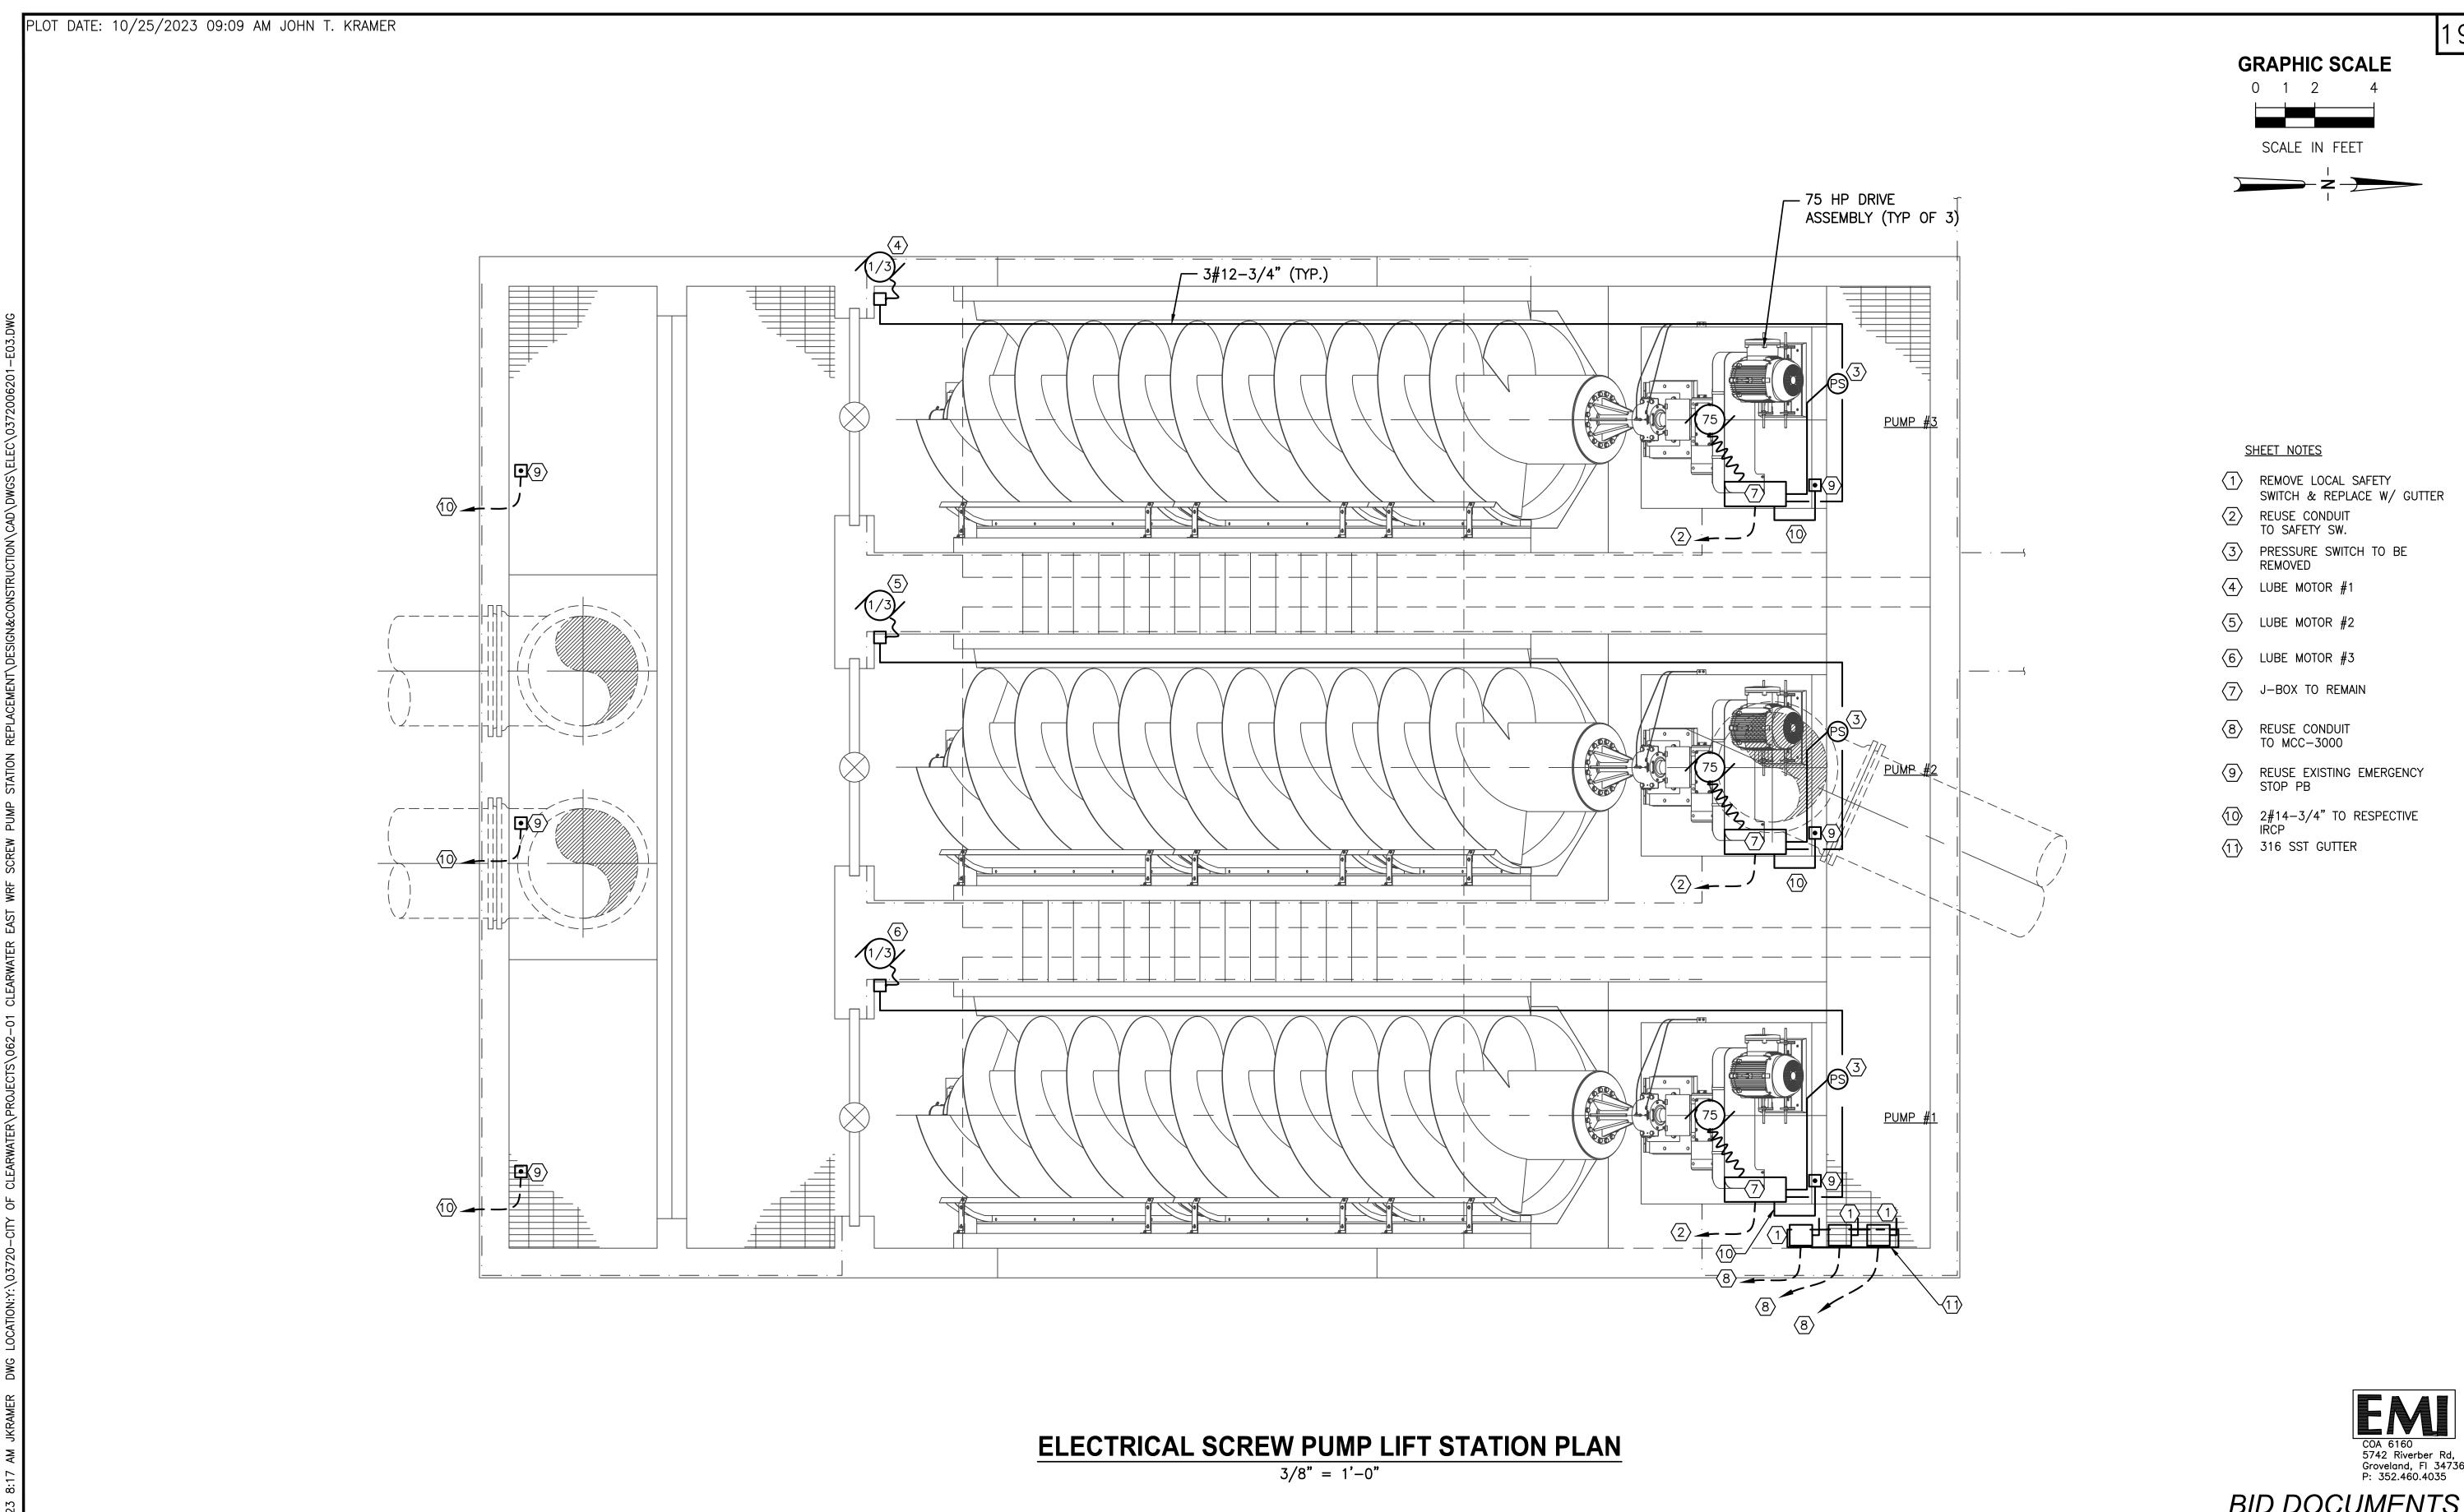

	BID DOCUMENTS							
	FIELD BOOK:	SURVEYED BY:	SCALE:					
VG			VERT					
	DATE DRAWN:	DRAWN BY:						
	OCTOBER 2023	JPH	HORIZ.					

25/	RECORD DRAWINGS			CALL 811		EAST WRF	0372006201-E03.DWG	, , , , , , , , , , , , , , , , , , ,	35KVZ125 5	VERT.
0/2	SURVEYED BY: DRAWN BY:		CITY OF CLEARWATER, FLORIDA	W CALL OI I			CONTRACT NO.:	DATE DRAWN:	DRAWN BY:	
-	REVIEWED BY:		ENGINEERING DEPARTMENT	SUNSHINE STATE ONE CALL OF FLORIDA	JonesEdmund\$)	SCREW PUMP REPLACEMENT	JOB NO.:	OCTOBER 2023 DESIGNED BY:	CHECKED BY:	HORIZ. SHEET NO.:
Ü	PROJECT ENGINEER DATE		100 SOUTH MYRTLE AVENUE	OF FLORIDA				WCH	WCH	E3
S\ S\	APPROVED BY:		CLEARWATER, FL 33756	www.sunshine811.com	730 NE WALDO ROAD, GAINESVILLE, FLORIDA 32641 / (352) 377-5821	ELECTRICAL SCREW PUMP	APPROVED FOR CONSTRUCTION			
<u> </u>	<u></u>	77//2/2/	Chiattwarmit, 11 00100	(800) 432-4770 MIN. 48 HOURS BEFORE YOU EXCAVATE	324 3. HTDL FARK AVL., SUITE 230 HAWEA, FLORIDA 33000 7 (813) 230-0703	LIFT STATION PLAN	CONSTRUCTION			
LAS	CITY ENGINEER, PUBLIC WORKS TARA KIVETT, P.E. #86611 DATE	REVISION BY DATE		BEFORE YOU EXCAVATE				WILLARD C. HOANSHELT,	PE #42592	DATE




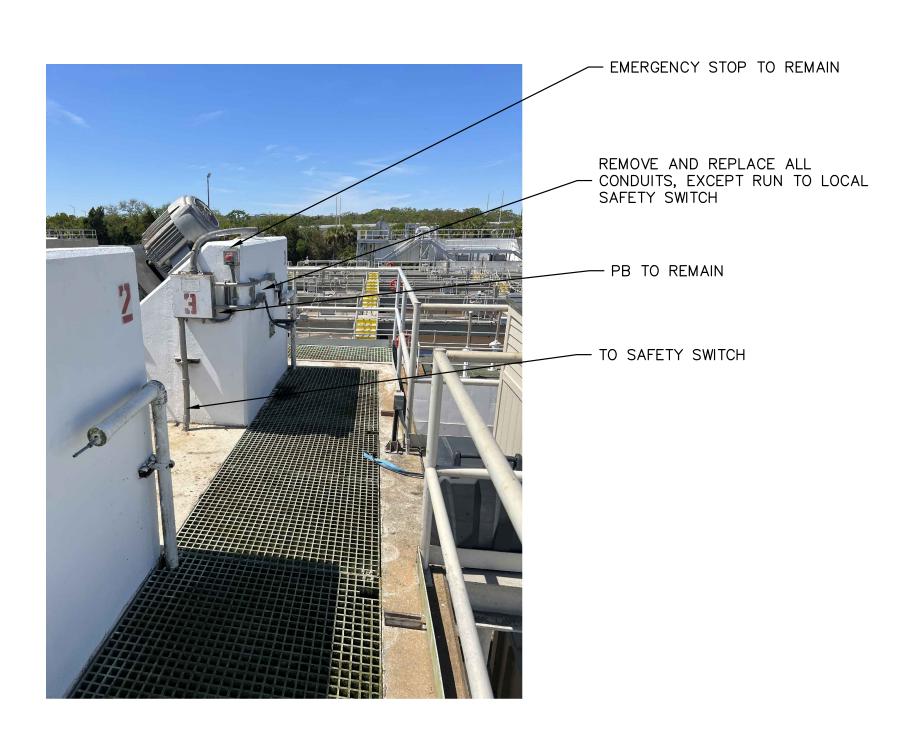



PHOTO: TYPICAL MOTOR END VIEW

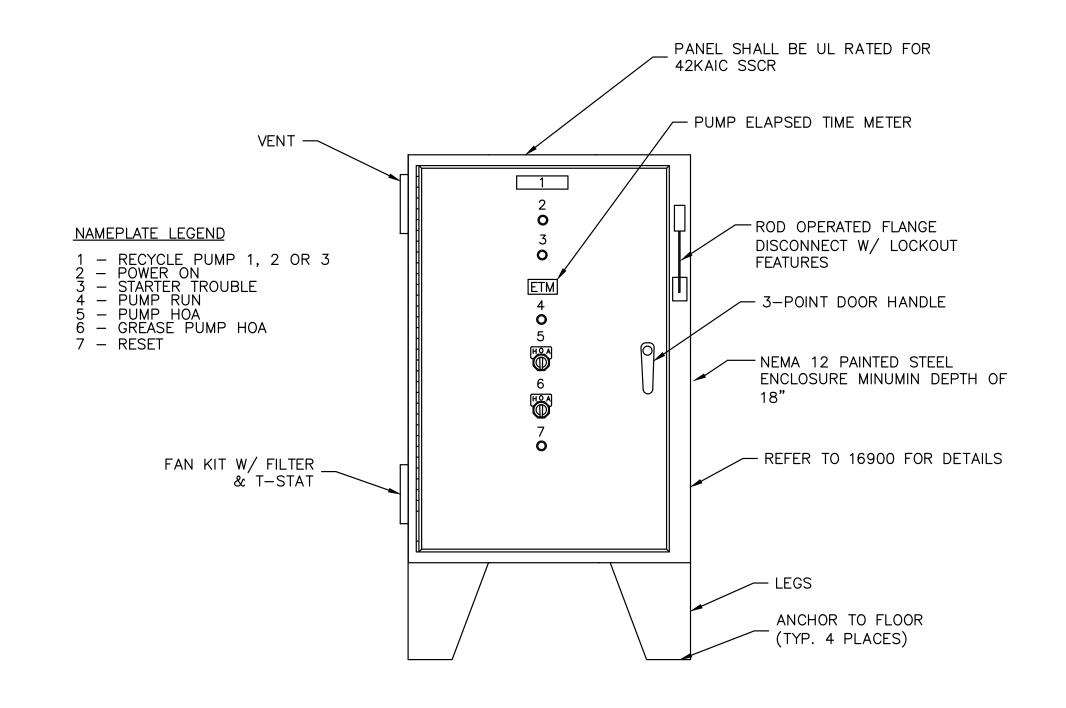

INTERNAL RECYCLE PUMP CONTROL PANEL

(TYP. 3 PLACES)

<u>FRONT VIEW</u>

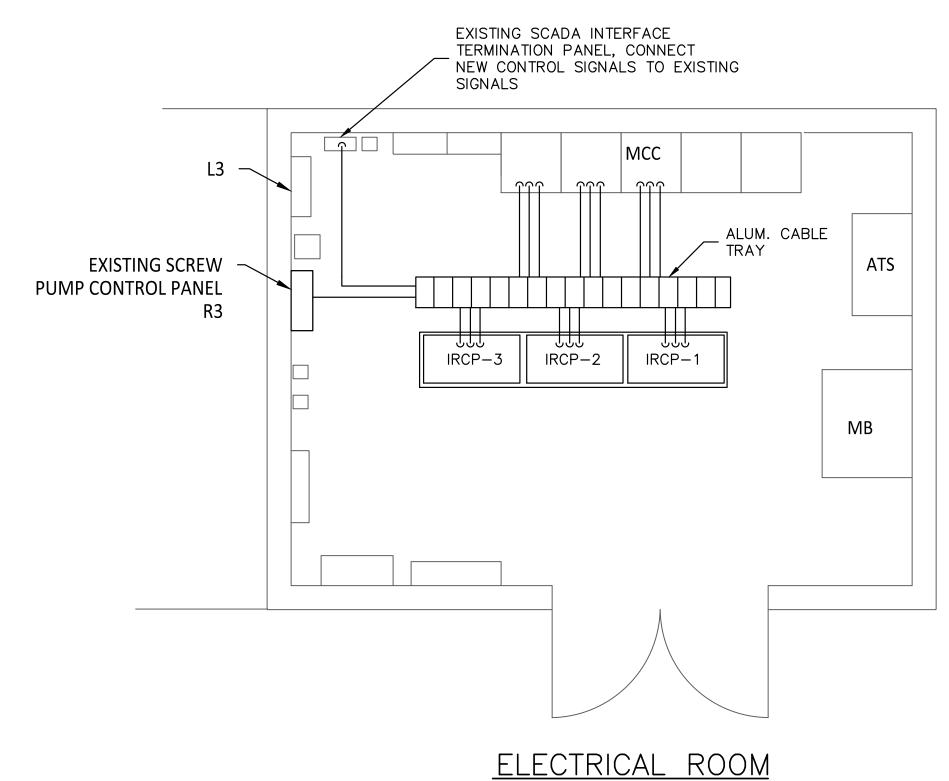

COA 6160 5742 Riverber Rd, Groveland, Fl 34736 P: 352.460.4035

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CITY OF CLEARWATER, FLORIDA ENGINEERING DEPARTMENT 100 SOUTH MYRTLE AVENUE CLEARWATER, FL 33756 INVESTIGATE BEFORE YOU EXCAVATE

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SCREW		WRF REPLACEMENT				
ELECTRICAL ROOM PLAN AND DETAILS						

DWG NAME:	FIELD BOOK:	SURVEYED BY:	SCALE:
0372006201-E04.DWG			VERT.
CONTRACT NO.:	DATE DRAWN:	DRAWN BY:	
	OCTOBER 2023	JPH	HORIZ.
JOB NO.:	DESIGNED BY:	CHECKED BY:	SHEET NO.:
	WCH	WCH	L4
APPROVED FOR CONSTRUCTION			
-	WILLARD C. HOANSHELT, PE	: #42592	DATE